

4'-0"

2x6 PRESSURE
TREATED LUMBER

POWER DISTRIBUTION CENTER
WITH NEMA 4 ENCLOSURE BY
UV MANUFACTURER

19
10

2-4/2'S IN ½" CONDUIT
FROM MOTOR
CONTROL CENTER
GROUND AS
PER NEC.

4x4 PRESSURE
TREATED POST


NOTES: 1. THE CHANNEL FLOOR MUST BE KEPT WITHIN A

2. DIMENSION OF CHANNEL WIDTH MUST BE KEPT WITHIN A TOLERANCE OF 1/4".

TOLERANCE OF 1/4".

2 *12's IN 34" CONDUIT FROM MOTOR CONTROL CENTER

POWER DISTRIBUTION CONTROL SCHEMATIC SCALE: NONE

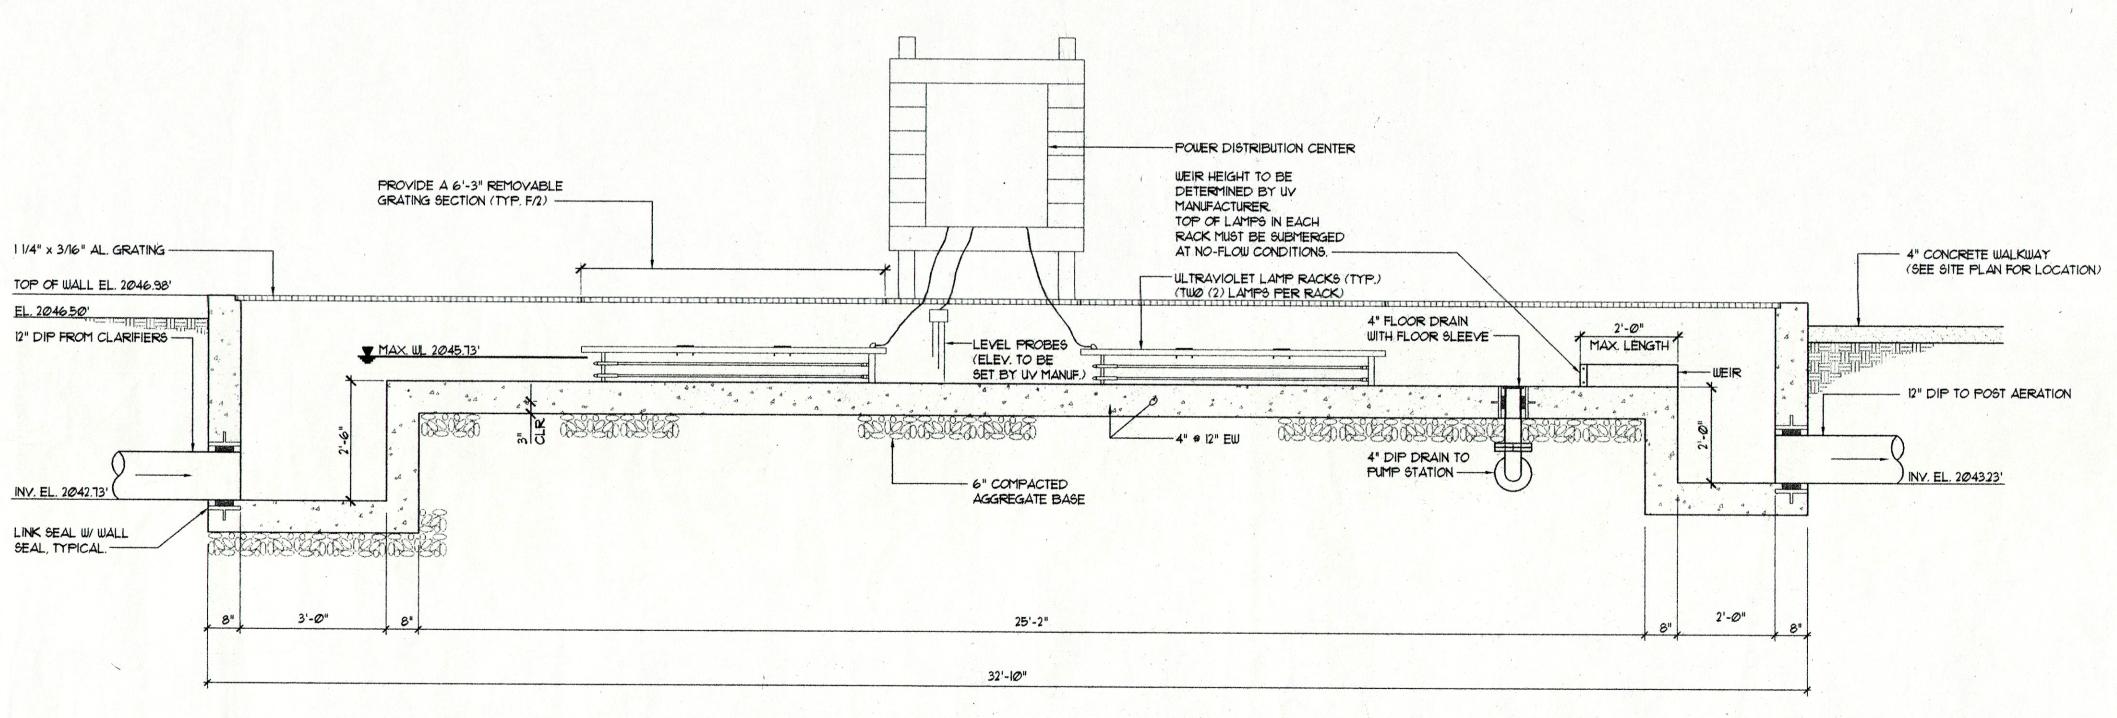

A ULTRAVIOLET DISINFECTION SYSTEM SECTION
SCALE: 1/2" = 1'-0"

SAI SILLING ASSOCIATES, INC.

ARCHITECTS · PLANNERS

405 CAPITOL STREET · SUITE 300 · BOX 867
CHARLESTON, W. V. 25323 · (304)346-0665

This drawing and all prints of it are the property of SILLING ASSOCIATES, IMC. (SAI). Prints are to be returned to SAI upon completion of use for which they were issued. Reproduction of this drawing without the written consent of SAI is not permitted.

ROSSER FABRAP

Rosser Fabrap International
Architects, engineers, and planners:
Atlanta, Savannah, Tampa, San Bernardino County
524 West Peachtree Street, N W
Atlanta, Georgia 30308 0680
(404) 876 3800

SEAL

R. C. R. CHAO

OISTER

NO. 6850
STATE OF

OSTER

CHITE

CHI

REVISIONS

1. 7/15/96 - REPLACED CHLORINE
CONTACT TANK WITH
UV DISINFECTION
CHANNEL

2. 6/26/97 - RECORD DRAWING

E CORRECTIONAL CENTER

ONSVIL

KEY PLAN

DRAWING TITLE

ULTRAVIOLET
DISINFECTION SYSTEM
PLAN, SECTION, DETAIL

24 JULY 1995

DRAWING NO.

13