

No.	Date	Description
1	1-30-2013	Addendum #4

Revisions

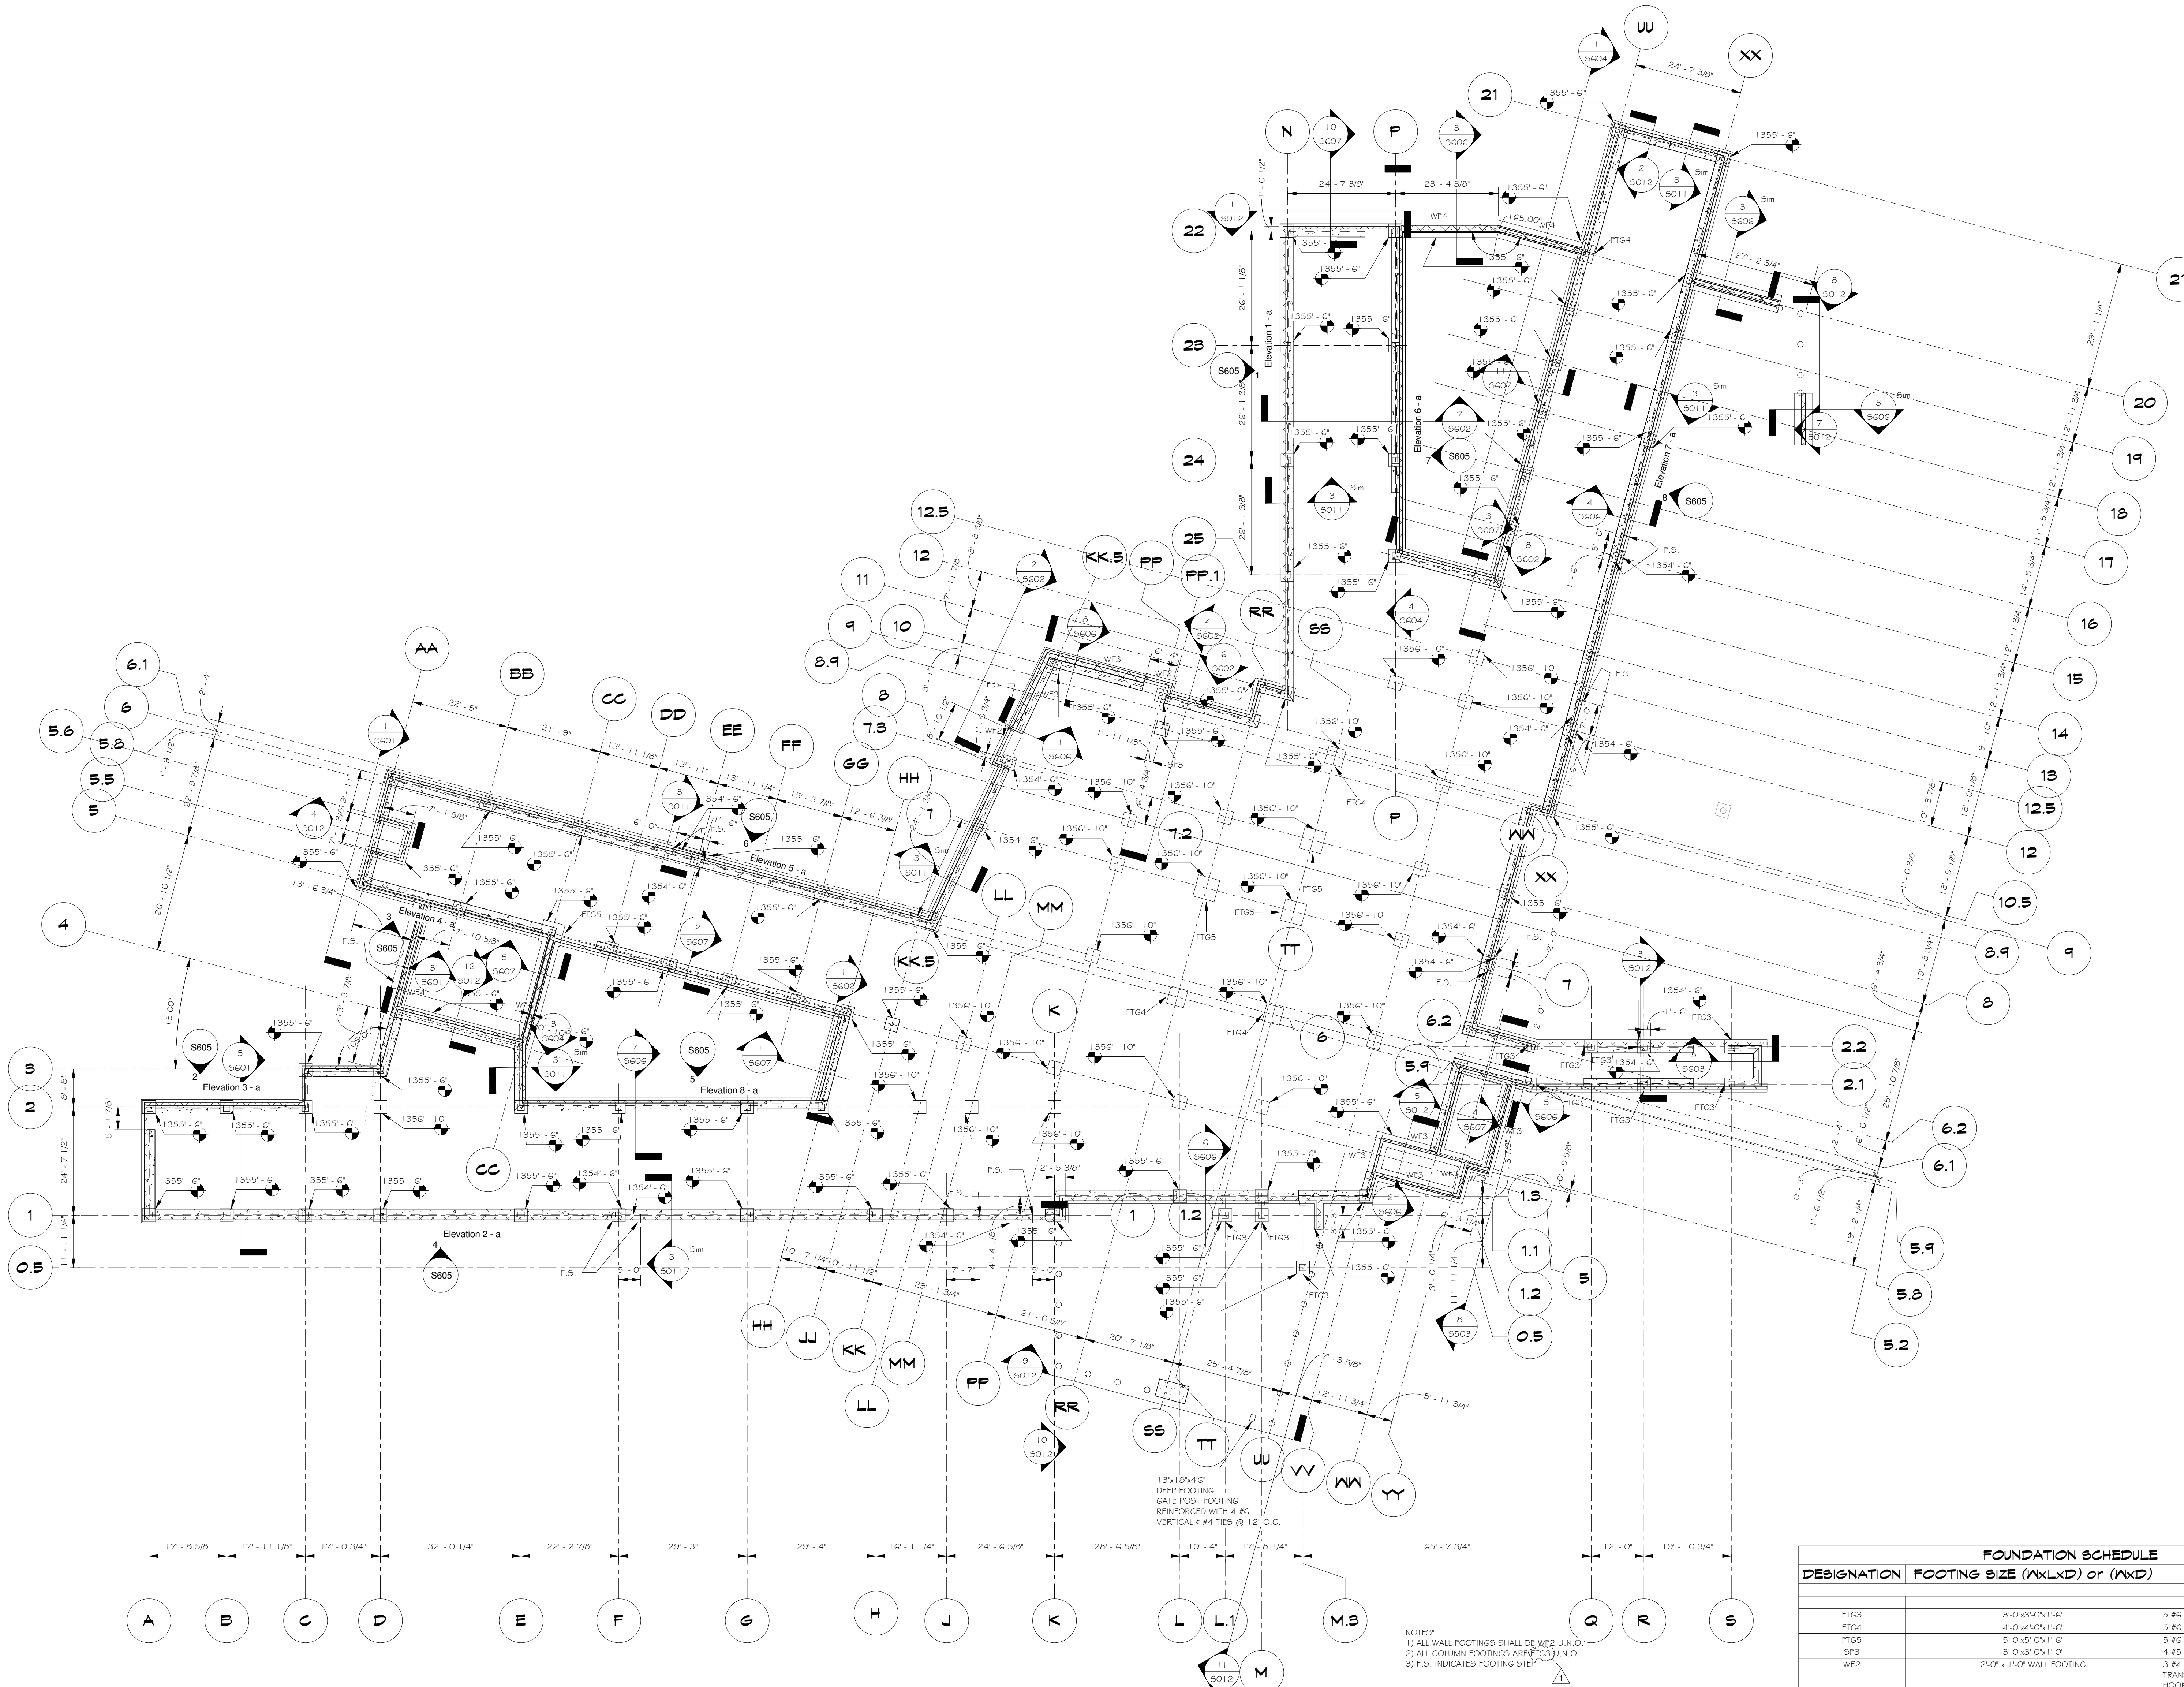
Date  
14 NOV 2012

Project Title  
William R. Sharpe  
Hospital  
50 Bed Addition

Drawing Title  
FOUNDATION PLAN

Project Number  
11-170  
Drawing Number  
S010

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13x18x42"  
DEEP FOOTING  
GATE POST FOOTING  
REINFORCED WITH 4 #6  
VERTICAL #4 TIES @ 12" O.C.

NOTES:  
 1) ALL WALL FOOTINGS SHALL BE WF2 U.N.O.  
 2) ALL COLUMN FOOTINGS ARE FTG3 U.N.O.  
 3) F.S. INDICATES FOOTING STOP

FOUNDATION SCHEDULE		
DESIGNATION	FOOTING SIZE (WxLxD) or (WxD)	REINFORCEMENT
FTG3	3'-0"x3'-0"x1'-6"	5 #6 E.W. BOTTOM HOOKED ENDS
FTG4	4'-0"x4'-0"x1'-6"	5 #6 E.W. BOTTOM HOOKED ENDS
FTG5	5'-0"x5'-0"x1'-6"	5 #6 E.W. BOTTOM HOOKED ENDS
SF3	3'-0"x3'-0"x1'-0"	4 #5 E.W. BOTTOM
WF2	2'-0" x 1'-0" WALL FOOTING	3 #4 LONGITUDINAL BOTTOM, #4 @ 12" O.C. TRANSVERSE BOTTOM TRANSVERSE BARS HOOKED ON ENDS
WF3	Bearing Footing - 36" x 12"	5 #5 LONGITUDINAL BOTTOM, #5 TRANSVERSE @ O.C. BOTTOM TRANSVERSE BARS HOOKED ON ENDS
WF4	4'-0" x 1'-6" WALL FOOTING	6 #5 LONGITUDINAL BOTTOM, #5 TRANSVERSE (T&B) @ O.C. BOTTOM TRANSVERSE BARS HOOKED AT ENDS

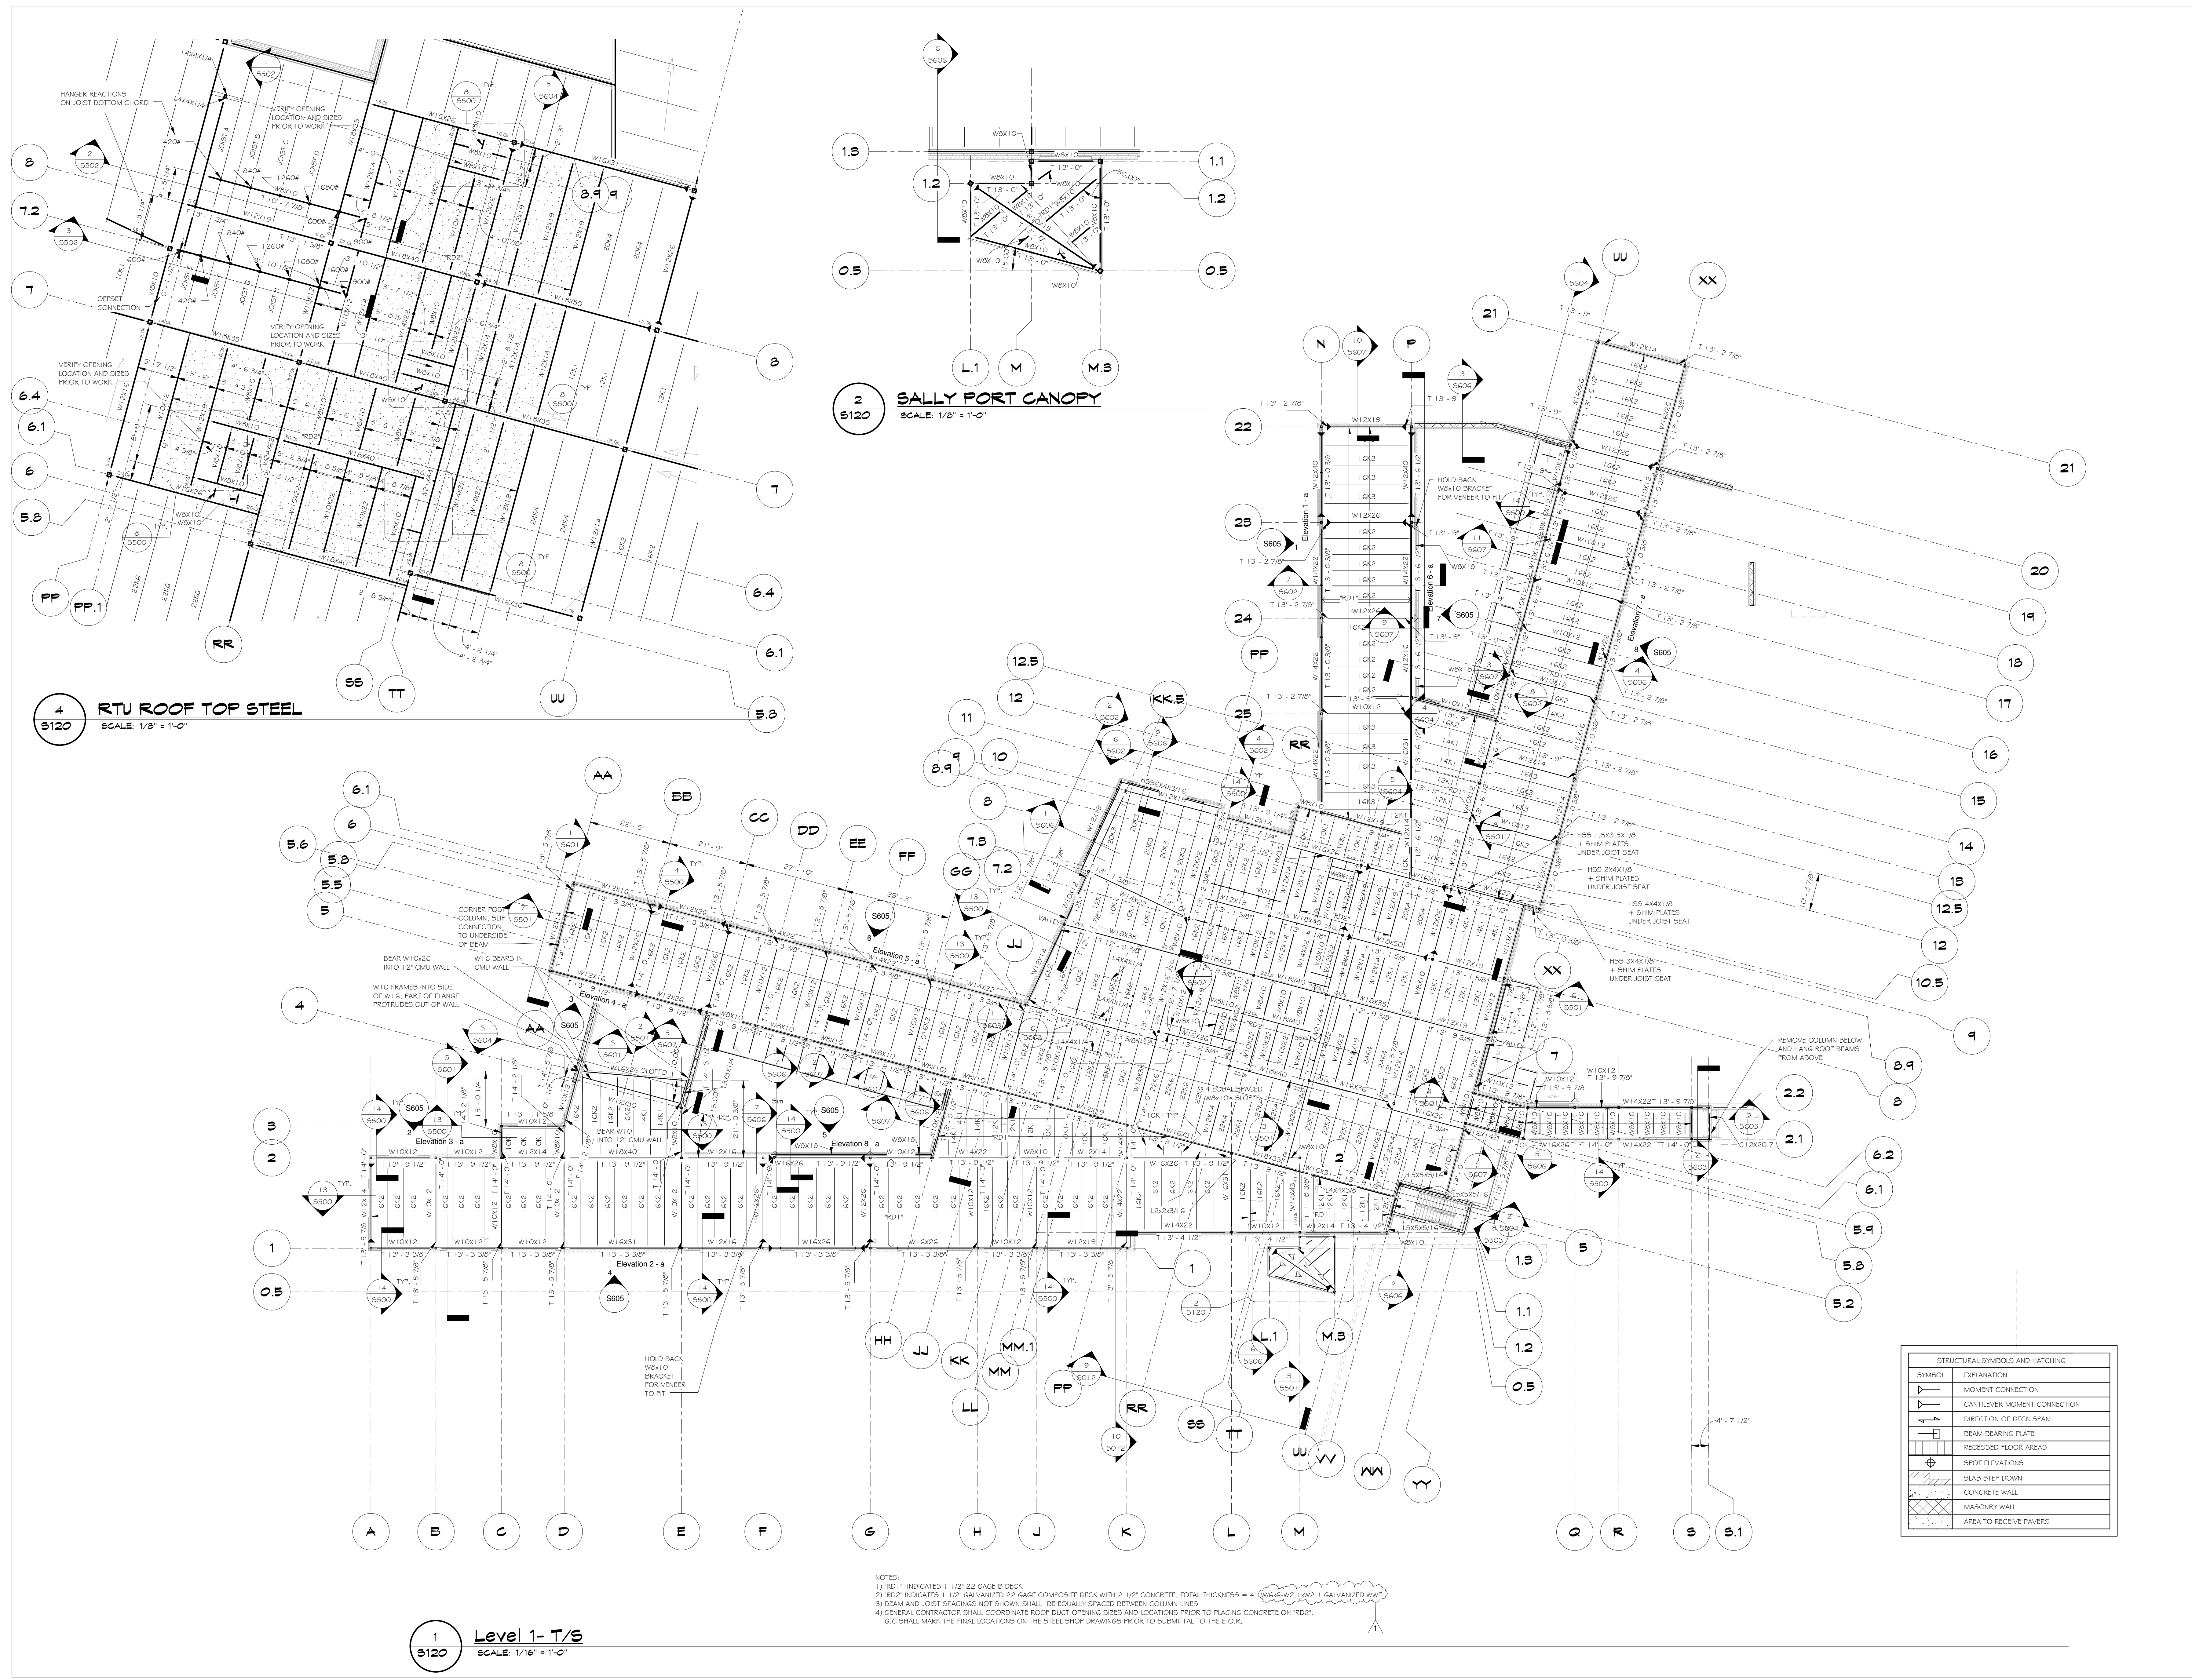
1 FOUNDATION LEVEL  
 SCALE: 1/16" = 1'-0"

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 14 NOV 2012  
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 LEVEL 2 FRAMING  
 PLAN

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 S120



**2 SALLY FORT CANOPY**  
 SCALE: 1/8" = 1'-0"

**4 RTU ROOF TOP STEEL**  
 SCALE: 1/8" = 1'-0"

**1 Level 1- T/S**  
 SCALE: 1/16" = 1'-0"

NOTES:  
 1) 'RD1' INDICATES 1 1/2" GAGE B DECK.  
 2) 'RD2' INDICATES 1 1/2" GALVANIZED 22 GAGE COMPOSITE DECK WITH 2 1/2" CONCRETE. TOTAL THICKNESS = 4" (W/2" W2, 1 W/2" GALVANIZED WWF).  
 3) BEAM AND JOIST SPACINGS NOT SHOWN SHALL BE EQUALLY SPACED BETWEEN COLUMN LINES.  
 4) GENERAL CONTRACTOR SHALL COORDINATE ROOF DUCT OPENING SIZES AND LOCATIONS PRIOR TO PLACING CONCRETE ON 'RD2'.  
 5) G.C SHALL MARK THE FINAL LOCATIONS ON THE STEEL SHOP DRAWINGS PRIOR TO SUBMITTAL TO THE E.O.R.

STRUCTURAL SYMBOLS AND HATCHING	
SYMBOL	EXPLANATION
	MOMENT CONNECTION
	CANTILEVER MOMENT CONNECTION
	DIRECTION OF DECK SPAN
	BEAM BEARING PLATE
	RECESSED FLOOR AREAS
	SPOT ELEVATIONS
	SLAB STEP DOWN
	CONCRETE WALL
	MASONRY WALL
	AREA TO RECEIVE PAVERS