

GENERAL NOTES

1. REFER TO SHEET E001 AND M001 FOR ADDITIONAL NOTES. 2. ALL HYDRONIC PIPE SHALL BE MOUNTED AS HIGH AS POSSIBLE

- TO THE UNDER SIDE OF THE STEEL STRUCTURE. 3. REFER TO THE ROOM VENTILATION SCHEDULE FOR ROOM
- NAMES AND NUMBERS ON SHEET M602.
 4. REFER TO THE STRUCTURAL DRAWINGS FOR COMPLETE
- **⊗ PLAN NOTES**

STRUCTURAL DESIGN.

1_1/2" HWS AND HWR UP TO AHU.

IN CONNECTING CORRIDOR. REFER TO ROOF PLAN FOR CONTINUATION AND ARCHITECTURAL CORRIDOR DETAILS FOR ADDITIONAL INFORMATION.

- CONTRACTOR SHALL ROUTE 3/4" HWS & HWR TO THE UNIT.
- 4 PROVIDE SHUT-OFF VALVE IN VERTICAL OF HWS & HWR.
- 5 CHWS AND CHWR 4" UP TO AHU.




IKM Incorporated One PPG Place

Pittsburgh, PA 15222




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Bid Set

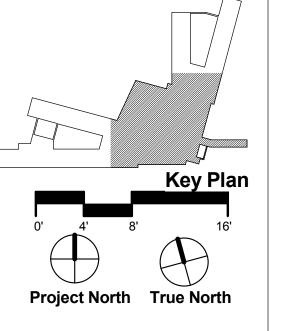

Date 14 November 2012 **Project Title**

WILLIAM R SHARPE HOSPITAL

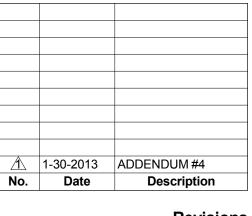50 Bed Addition


936 Sharpe Hospital Road Weston, WV 26452-8550 **Drawing Title**

OFFICE AND SALLY PORT - HVAC PIPING

Project Number

11-170

Drawing Number M203

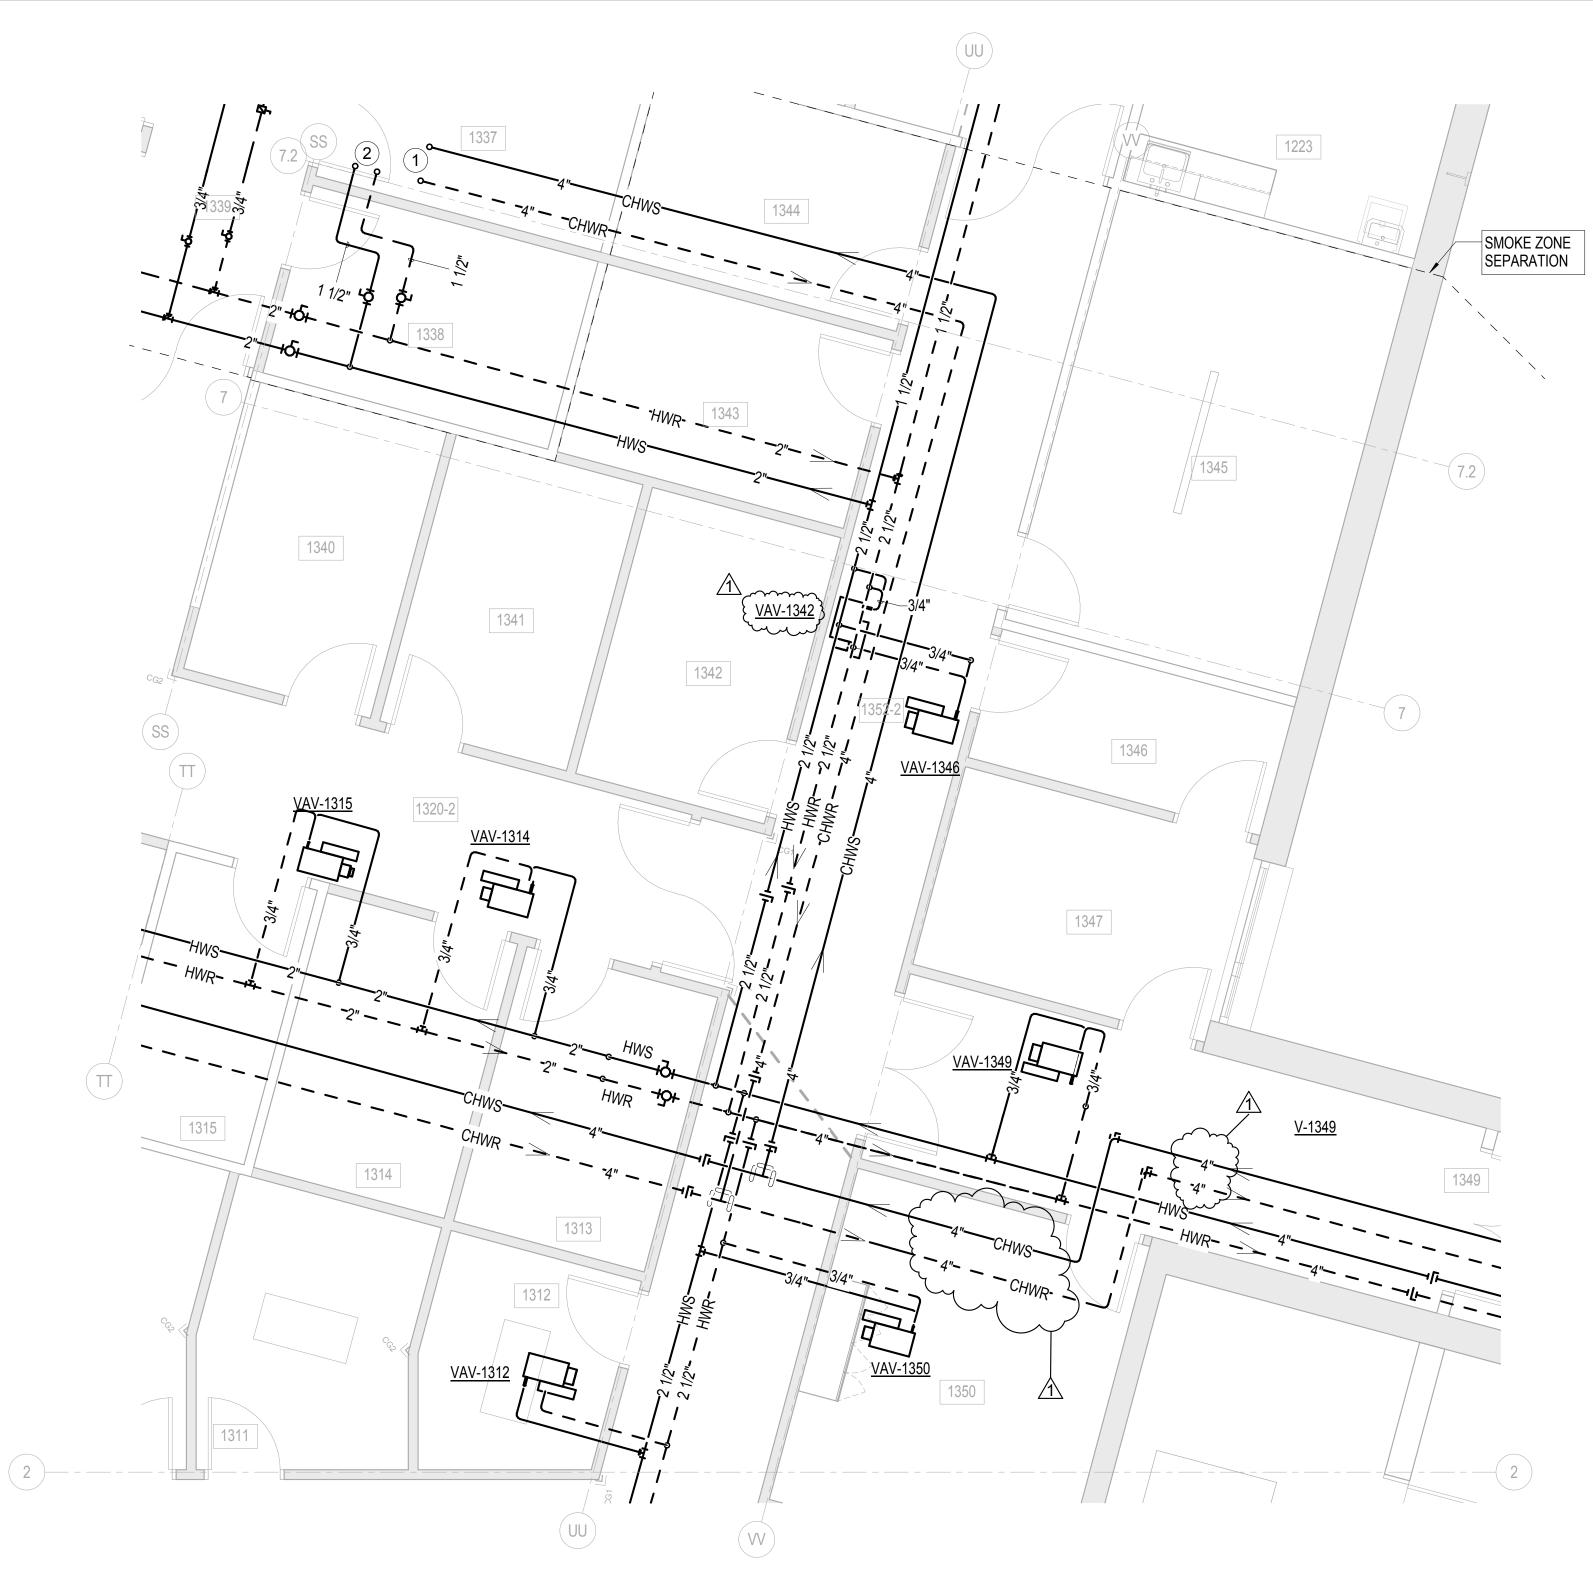

ENLARGED PLAN M-1

SCALE: 1/4" = 1'-0"

GENERAL NOTES

REFER TO SHEET E001 AND M001 FOR ADDITIONAL NOTES.
 ALL HYDRONIC PIPE SHALL BE MOUNTED AS HIGH AS POSSIBLE TO THE UNDER SIDE OF THE STEEL STRUCTURE.
 REFER TO THE ROOM VENTILATION SCHEDULE FOR ROOM NAMES AND NUMBERS ON SHEET M602.
 REFER TO THE STRUCTURAL DRAWINGS FOR COMPLETE STRUCTURAL DESIGN.

⊗ PLAN NOTES


- 1 CHWS AND CHWR 4" UP TO AHU.
- 2 1 1/2" HWS AND HWR UP TO AHU.




Pittsburgh, PA 15222




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Date 14 November 2012 **Project Title**

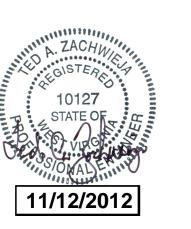WILLIAM R SHARPE HOSPITAL 50 Bed Addition

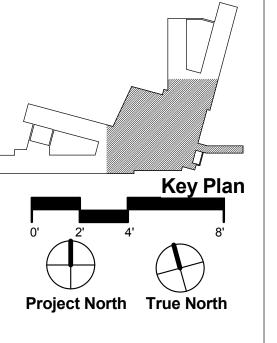WSH13095

936 Sharpe Hospital Road Weston, WV 26452-8550

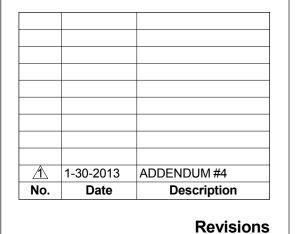Drawing Title ENLARGED FLOOR PLANS

Project Number

11-170

Drawing Number M204

GENERAL NOTES

1. REFER TO SHEET E001 AND M001 FOR ADDITIONAL NOTES.

CONTRACTOR SHALL COORDINATE, FIELD VERIFY, AND CONNECT TO EXISTING VALVED AND CAPPED CHWS, CHWR, 5 HWS, AND HWR PIPING INSTALLED BY OTHERS ON EXISTING 1 BUILDING ROOF IN THIS AREA AS REQUIRED. CONTRACTOR SHALL PROVIDE 2" TAP AND CONNECTIONS WITH 2" BALL VALVE WITH FEMALE ENDS AND PLUG TO FACILITATE FLUSHING AND FILLING OF PIPING. FILL, FLUSH, AND CLEAN NEW PIIPING SYSTEMS AS SPECIFIED. FINAL FLUSH SHALL INCLUDE "LAY-UP INHIBITOR" UNLESS GLYCOL MIX IS ADDED IMMEDIATELY AFTER FINAL FLUSH. COORDINATE FLUSHING, FILLING, AND BALANCING WITH OTHER CONTRACTORS

FURNISH AND INSTALL 4 #3 AWG CU AND #8 CU GROUND IN 1 1/4" CONDUIT FOR AHU-13 AND AHU-14.

 $_{_{
m C}}$ INVOLVED WITH BUILDING RENOVATIONS PROJECT. $_{\sim}$ " which was the same with the

- FURNISH AND INSTALL 3 #10 AWG CU AND #10 CU GROUND FOR HEATERS EH-1 AND EH-2.
- FURNISH AND INSTALL 2 #10 AWG AND #12 GROUND FOR LIGHTING AND RECEPTACLES.
- FURNISH AND INSTALL 2 #8 AWG AND #12 GROUND FOR LIGHTING AND RECEPTACLES.
- FURNISH AND INSTALL 2 #12 AWG CU AND #12 CU GROUND FOR TEMPERATURE CONTROL-PANEL.
- DOWN TO "V" FIXTURE ON FIRST FLOOR.
- CONTRACTOR SHALL PROVIDE DIFFERENTIAL PRESSURE TRANSMITTER IN SERVICE COORIDOR OF AHU. REFER TO DETAIL AND CONTROLS DRAWINGS FOR ADDITIONAL INFORMATION. CONTRACTOR SHALL PROVIDE 1.5" CHW BY-PASS VALVE AND PIPING IN SERVICE CORRIDOR. SEE COIL PIPING DETAIL AND CONTROLS DETAIL FOR ADDITIONAL INFORMATION.
- E.C. SHALL CONNECT TO EXISTING ELECTRICAL PULL BOX ON ROOF WITH (2) 3" CONDUITS, INCLUDING WIRING, FOR EXTENSION OF EMERGENCY POWER TO MAIN ELECTRICAL ROOM IN ADDITION. THIS CONTRACTOR IS REPONSIBLE FOR PROPER SPLICING IN PULL BOX PER NEC REQUIREMENTS.
- 10 E.C. SHALL FURNISH AND INSTALL FOUR(4) 1" AND TWO(2) 2" EMPTY CONDUITS WITH PULL WIRE. CONNECT TO EXISTING CONDUITS ON ROOF AND EXTEND AS FOLLOWS: (1) 1" SHALL TERMINATE WITH A BUSHING IN ACCESSIBLE CEILING OF CONNECTING CORRIDOR; (5) REMAINING CONDUITS SHALL RUN IN CEILING SPACE TO MAIN ELECTRICAL ROOM AND TERMINATE WITH A BUSHING 1'-0" INTO ROOM.
- FURNISH AND INSTALL 2 #8 AWG AND #12 GND.
- 12 FURNISH AND INSTALL 2 #10 AWG AND #12 GND.
- EC SHALL RUN EXHAUST FANS' POWER THROUGH RELAY JUNCTION BOX (RELAY FURNISHED BY TCC) IN CEILING SPACE PRIOR TO THROUGH ROOF AND TERMINATION ON FAN. COORDINATE REQUIREMENTS WITH TEMPERATURE CONTROLS SUPPLIER/INSTALLER. JUNCTION BOX SHALL BE MINIMUM 4" X 4" X 3" DEEP.





architecture

IKM Incorporated

interior design


planning


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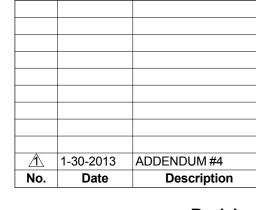
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WV 25177







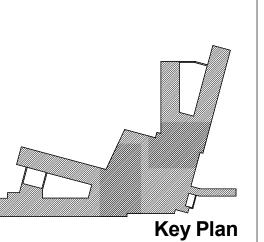

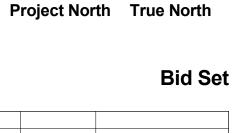Revisions

Date 14 November 2012 **Project Title WILLIAM R SHARPE**

> HOSPITAL 50 Bed Addition

> > WSH13095


936 Sharpe Hospital Road Weston, WV 26452-8550

Drawing Title ROOF PLAN

Project Number

11-170

Drawing Number MEP101

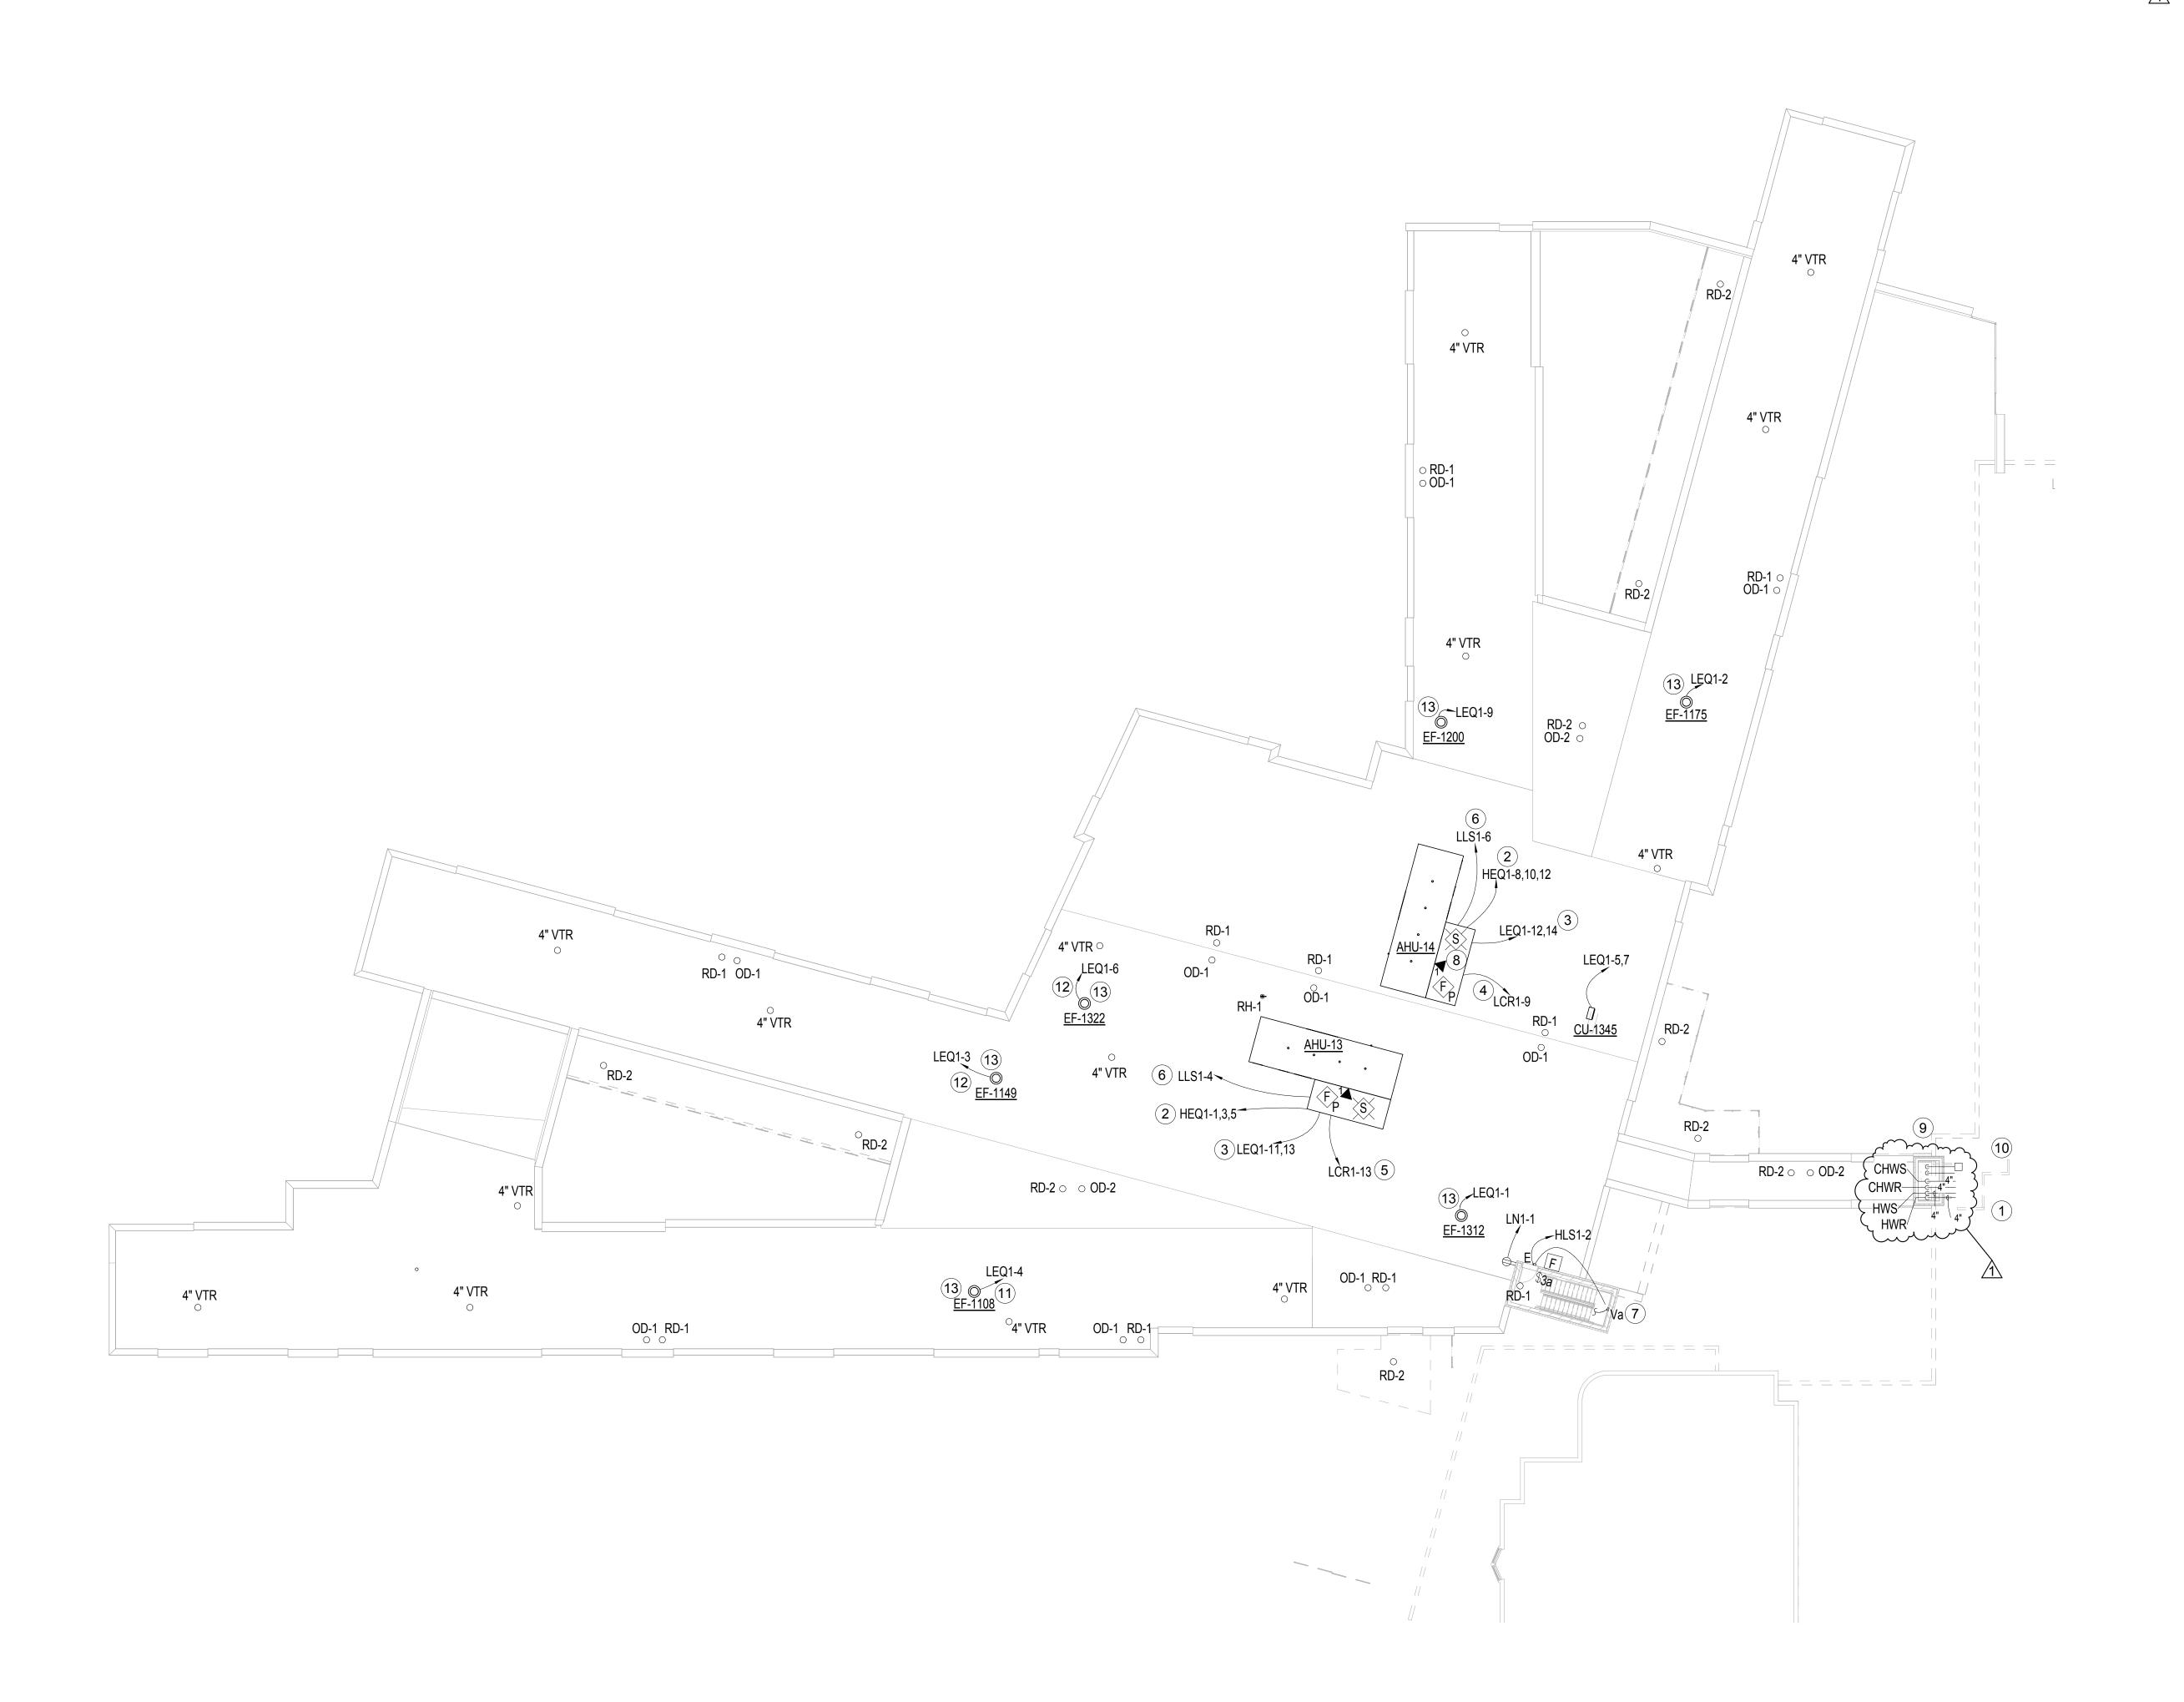

ROOF PLAN SCALE: 1/16" = 1'-0"




2 FURNISH AND INSTALL 3/4" INSULATED COPPER DRAIN FROM ICE MACHINE TO AN AIR GAP FITTING BELOW CABINET CONNECTED TO SINK DRAIN.

3 FURNISH AND INSTALL 1-1/2" VENT TO ALL WB-1 DRAINS.

GENERAL NOTES

1. REFER TO SHEET M001 AND E001 FOR ADDITIONAL NOTES.

2. REFER TO DRAWING P105 FOR RAIN WATER PIPING AND DOWNSPOUT NOZZLES NOT SHOWN ON THIS DRAWING.

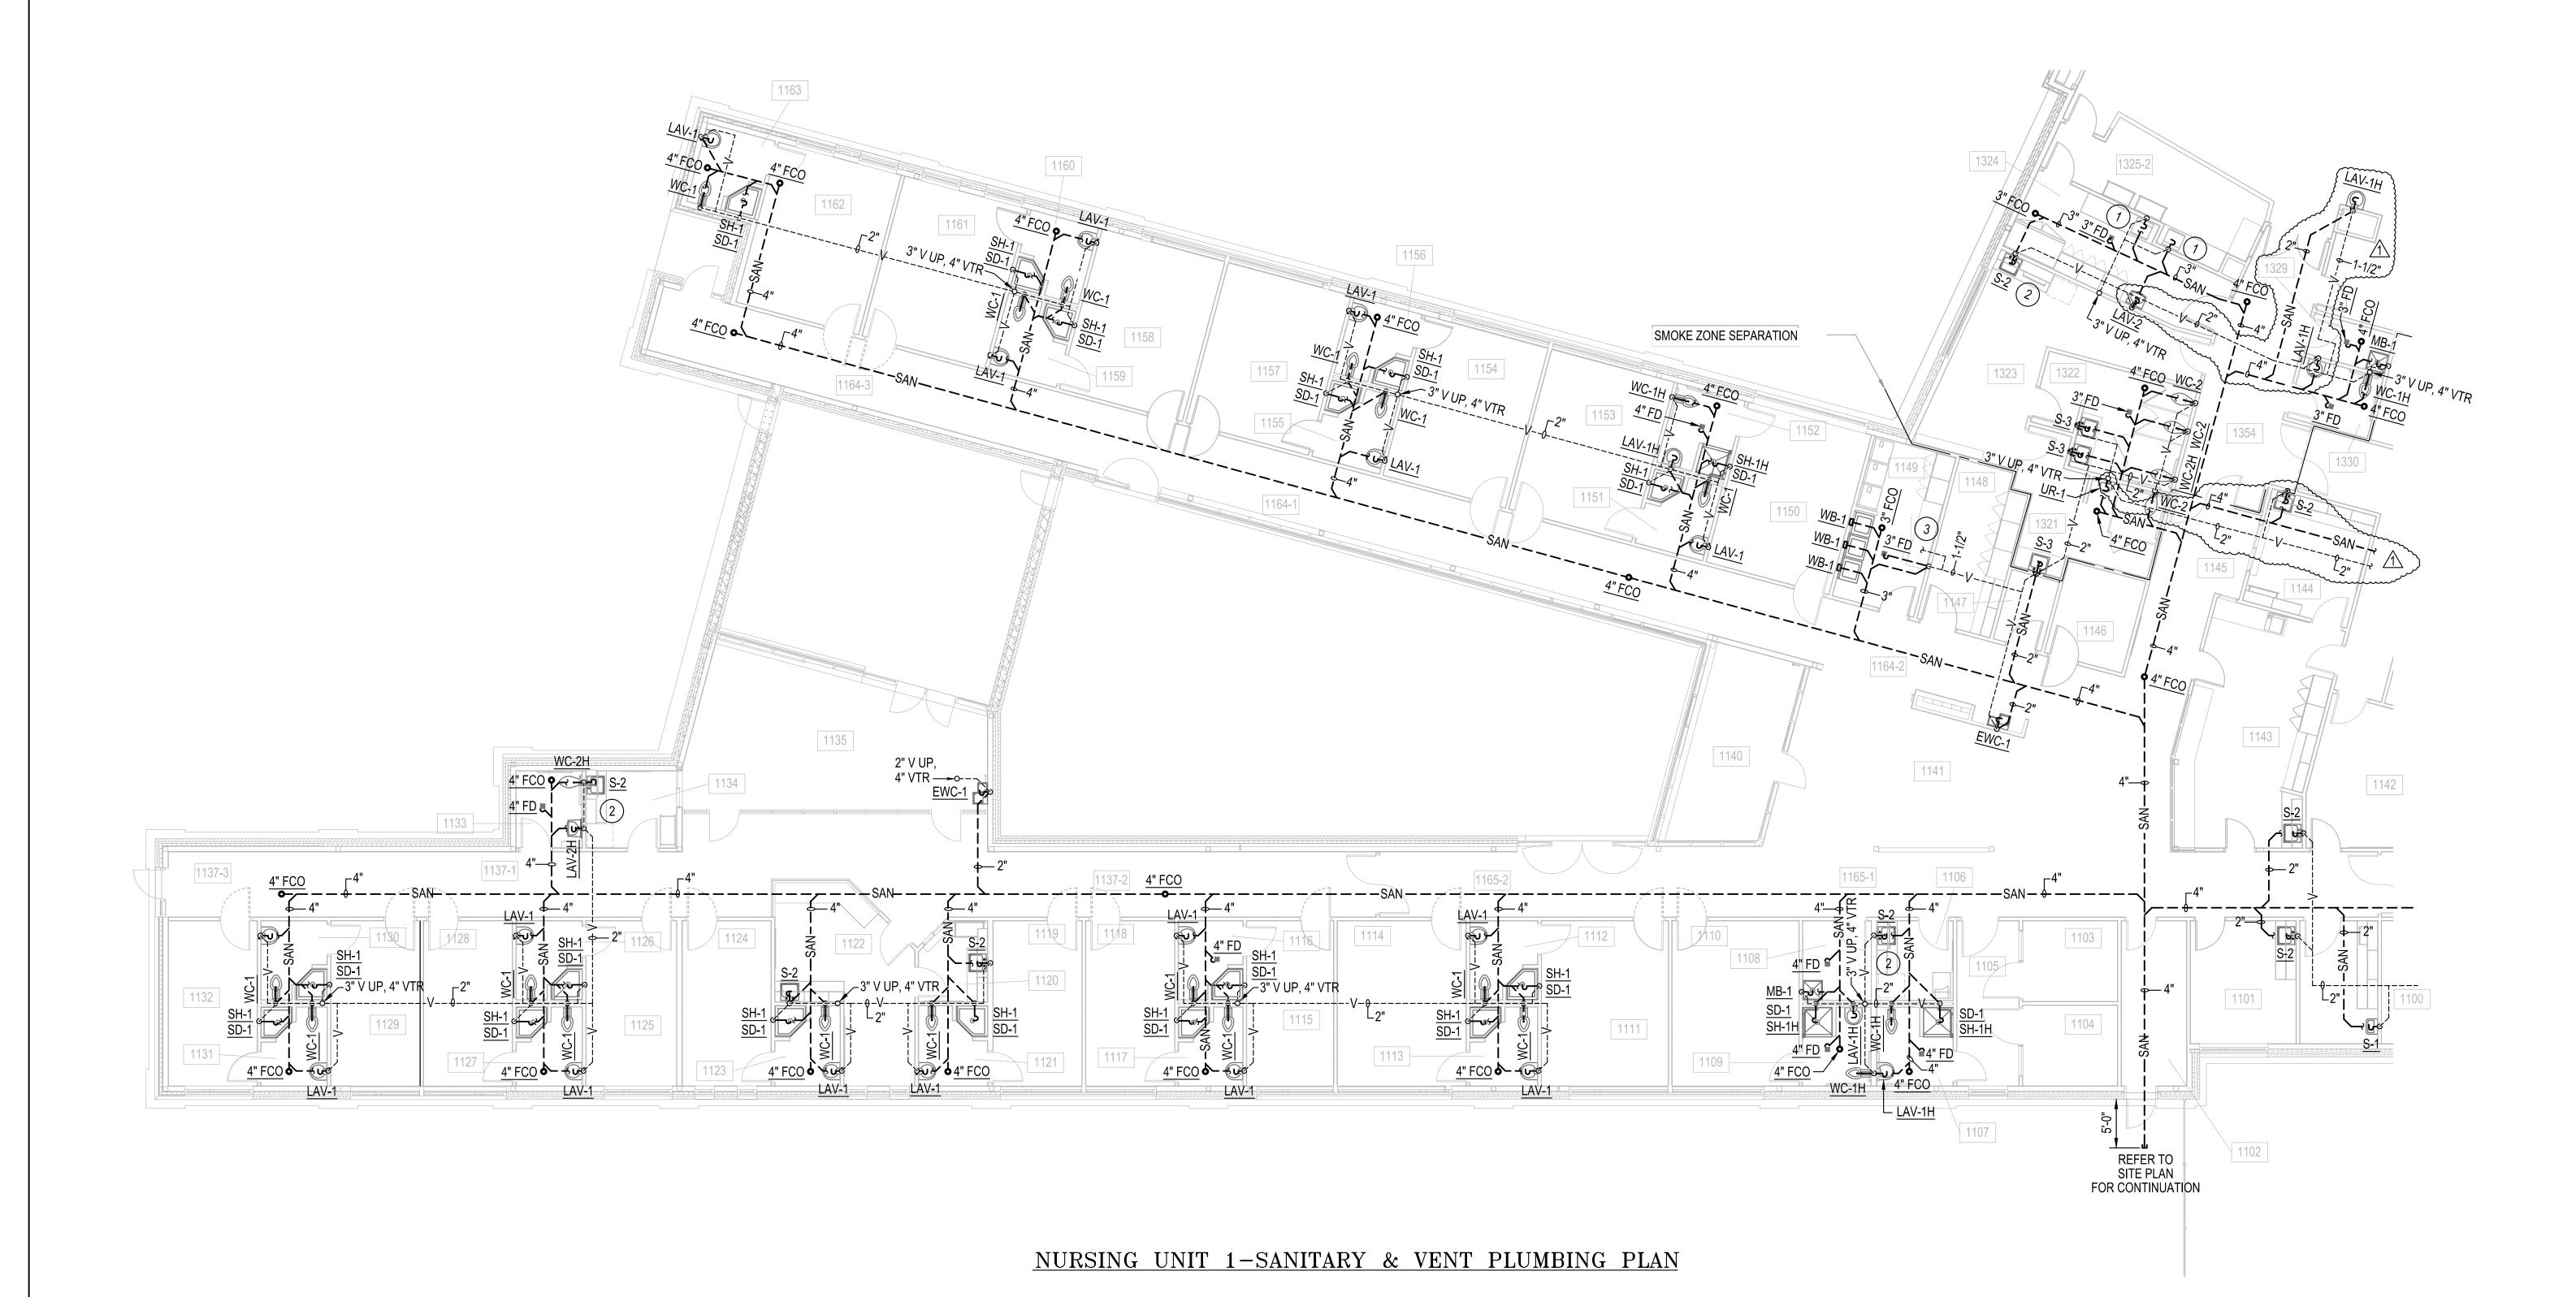



architecture
planning
interior design
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1-30-2013	ADDENDUM #4
Date	Description
	Revisions

Revisions

Date

Project Title
WILLIAM R SHARPE
HOSPITAL

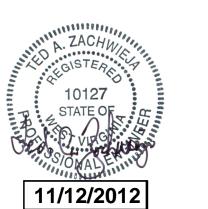50 Bed Addition

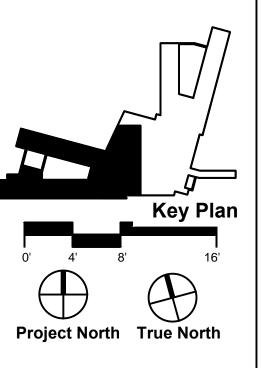WSH1309

936 Sharpe Hospital Road Weston, WV 26452-8550

Drawing Title
NURSING UNIT
1-SANITARY &
VENT PLUMBING
PLAN

Project Number

11-170

Drawing Number P101

REFER TO SITE PLAN FOR CONTINUATION SMOKE ZONE SEPARATION

NURSING UNIT 2-SANITARY & VENT PLUMBING PLAN

PLAN NOTES

PROVIDE INDIRECT 3" HUB DRAIN FOR BFP.
COORDINATE LOCATION OF DRAIN IN CLOSE PROXIMITY
TO BFP AIR GAP.

FURNISH AND INSTALL 3/4" INSULATED COPPER DRAIN FROM ICE MACHINE TO AN AIR GAP FITTING BELOW CABINET CONNECTED TO SINK DRAIN.

3 FURNISH AND INSTALL 1-1/2" VENT TO ALL WB-1 DRA

GENERAL NOTES

1. REFER TO SHEET M001 AND E001 FOR ADDITIONAL NOTES.


2. REFER TO DRAWING P105 FOR RAIN WATER PIPING AND DOWNSPOUT NOZZLES NOT SHOWN ON THIS DRAWING.






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Δ	1-30-2013	ADDENDUM #4
No.	Date	Description
		Revisions

Date
14 November 2012

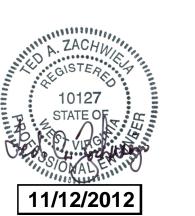Project Title
WILLIAM R SHARPE
HOSPITAL

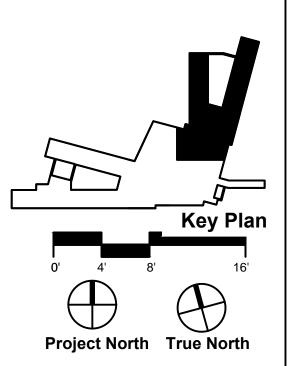50 Bed Addition

WSH1309

936 Sharpe Hospital Road Weston, WV 26452-8550

Drawing Title
NURSING UNIT
2-SANITARY &
VENT PLUMBING
PLAN

Project Number

11-170

Drawing Number P102



PLAN NOTES

- 1) SINK BY KITCHEN EQUIPMENT SUPPLIER.
- 2 CONTRACTOR SHALL RUN 3/4" INSULATED COPPER DRAIN FROM ROOF HYDRANT (RH-1) TO MB-1 IN ROOM
- 3 FURNISH AND INSTALL 3/4" INSULATED COPPER DRAIN FROM ICE MACHINE TO AN AIR GAP FITTING BELOW CABINET CONNECTED TO SINK DRAIN.
- 4 FURNISH AND INSTALL 2" FUNNEL DRAIN BELOW BEVERAGE CART WITH ICE MACHINE. RUN 3/4" INSULATED COPPER DRAIN FROM ICE MACHINE TO 2" FUNNEL DRAIN. MAINTAIN AIR GAP.
- 5 FURNISH AND INSTALL 1-1/2" VENT TO ALL WB-1 DRAINS.

GENERAL NOTES

1. REFER TO SHEET M001 AND E001 FOR ADDITIONAL NOTES.

2. REFER TO DRAWING P105 FOR RAIN WATER PIPING AND DOWNSPOUT NOZZLES NOT SHOWN ON THIS DRAWING.






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11/12/2012



Bid Set

Δ	1-30-2013	ADDENDUM #4
No.	Date	Description
		Revisions

Date
14 November 2012

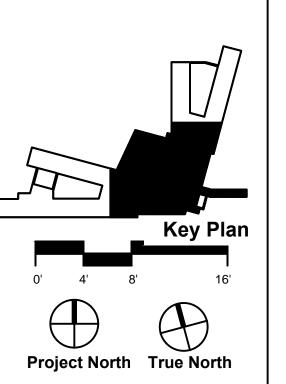Project Title
WILLIAM R SHARPE
HOSPITAL

50 Bed Addition

WSH13095

936 Sharpe Hospital Road Weston, WV 26452-8550

Drawing Title
OFFICE AND
SALLY PORT SANITARY & VENT
PLUMBING PLAN

Project Number 11-170

Drawing Number P103



GENERAL NOTES

- 1. REFER TO SHEET E001 AND M001 FOR ADDITIONAL NOTES 2. WATER HAMMER ARRESTORS (WHA-1) SHALL BE INSTALLED ON ALL CW BRANCH LINES TO TOILETS AND LAUNDRY AREAS/HW BRANCH PIPING TO LAUNDRY AREAS. UNITS SHALL BE INSTALLED IN AN ACCESSIBLE LOCATION.
- 3. TRAP PRIMERS SHALL BE FURNISHED AND INSTALLED FOR ALL FLOOR DRAINS. CW PIPING SHALL BE 1/2" TYPE K COPPER. PRIMERS AND DISTRIBUTION UNITS SHALL BE INSTALLED IN AN ACCESSIBLE LOCATION.
- 4. ALL SHUT-OFF VALVES SERVING THE PATIENT ROOMS SHALL BE LOCATED IN CORRIDOR ACCESSIBLE CEILING.
- 5. MINIMUM PIPE SIZE TO FIXTURES IS 3/4". REDUCE TO 1/2" AT
- FIXTURE WHERE 1/2" PIPE IS REQUIRED 6. ALL BRANCH LINES (CW/HW/TW) SHALL HAVE A SHUT-OFF VALVE FOR ISOLATION.
- 7. ALL PLUMBING FIXTURES PIPED WITH CW AND HW/TW SHALL BE INSTALLED WITH CW LOCATED ON THE RIGHT AND HW/TW ON
- 8. REFER TO ARCHITECTURAL DRAWINGS FOR MOUNTING HEIGHTS AND COORDINATION OF FINAL LOCATION OF DEVICES AND FIXTURES.
- 9. REFER TO SCHEDULE FOR REQUIRED SIZE(S) OF PIPING CONNECTIONS.
- 10. REFER TO THE ROOM VENTILATION SCHEDULE FOR ROOM NAMES AND NUMBERS ON SHEET M602

⊗ PLAN NOTES

REFER TO TYPICAL DOMESTIC WATER LAYOUT P-1.

- 2 REFER TO TYPICAL DOMESTIC WATER LAYOUT P-6.
- REFER TO TMV PIPING DETAIL FOR ADDITIONAL INFORMATION.
- 4 INSTALL A BALL VALVE FOR ISOLATION IN AN ACCESSIBLE LOCATION IN THE CORRIDOR TO TW/CW BRANCH LINES.

CONNECT TO EXISTING HW AND RHW IN MAIN HOSPITAL BUILDING. THIS CONTRACTOR SHALL BE RESPONSIBLE FOR FURNISHING AND INSTALLING THE 2" HW/2" RHW THROUGH THE NEW CONNECTING CORRIDOR AND INTO THE EXISTING HOSPITAL. THIS CONTRACTOR SHALL MAKE FINAL CONNECTIONS TO THE EXISTING PIPING INSTALLED DURING THE RENOVATIONS PROJECT. ASSUME CONNECTIONS TO EXISTING PIPING WILL BE A MAXIMUM OF 10'-0" PAST THE EXISTING BUILDING WALL AND CONNECTIONS WILL BE MADE

FURNISH AND INSTALL HW DISPENSER AT SINK S-2. REFER TO SCHEDULES.

ABOVE THE CEILING.




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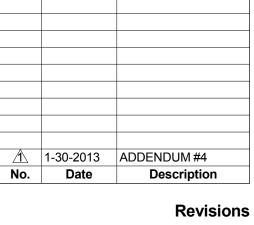


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Bid Set



Date

14 November 2012 **Project Title WILLIAM R SHARPE**

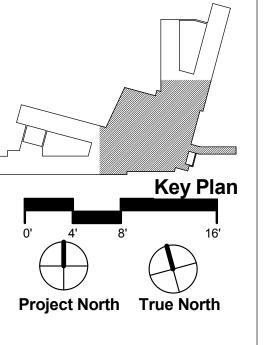HOSPITAL 50 Bed Addition

WSH13095


936 Sharpe Hospital Road Weston, WV 26452-8550

Drawing Title OFFICE AND SALLY PORT - DOMESTIC WATER

Project Number


11-170

Drawing Number P203

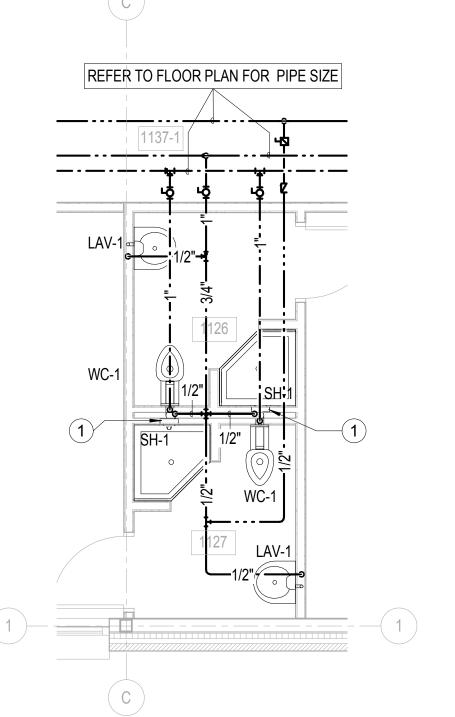


TYPICAL DOMESTIC PLUMBING LAYOUT P-1

SCALE: 1/4" = 1'-0"

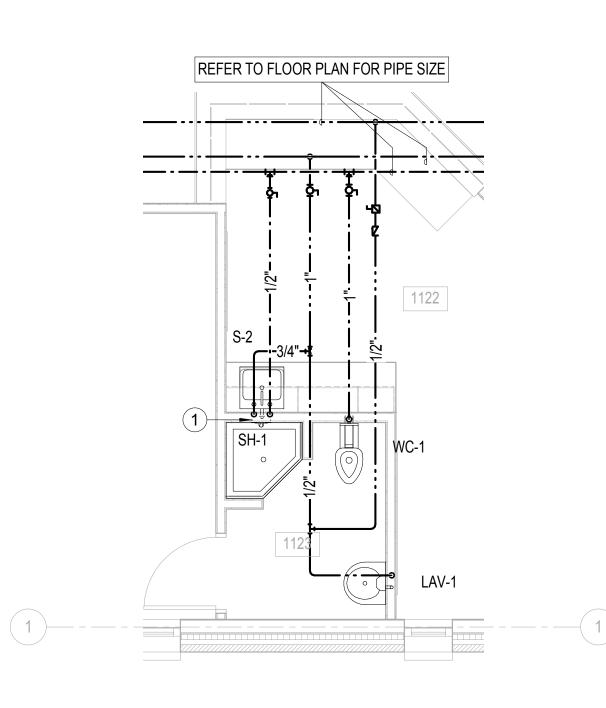


TYPICAL DOMESTIC PLUMBING LAYOUT P-2


SCALE: 1/4" = 1'-0"

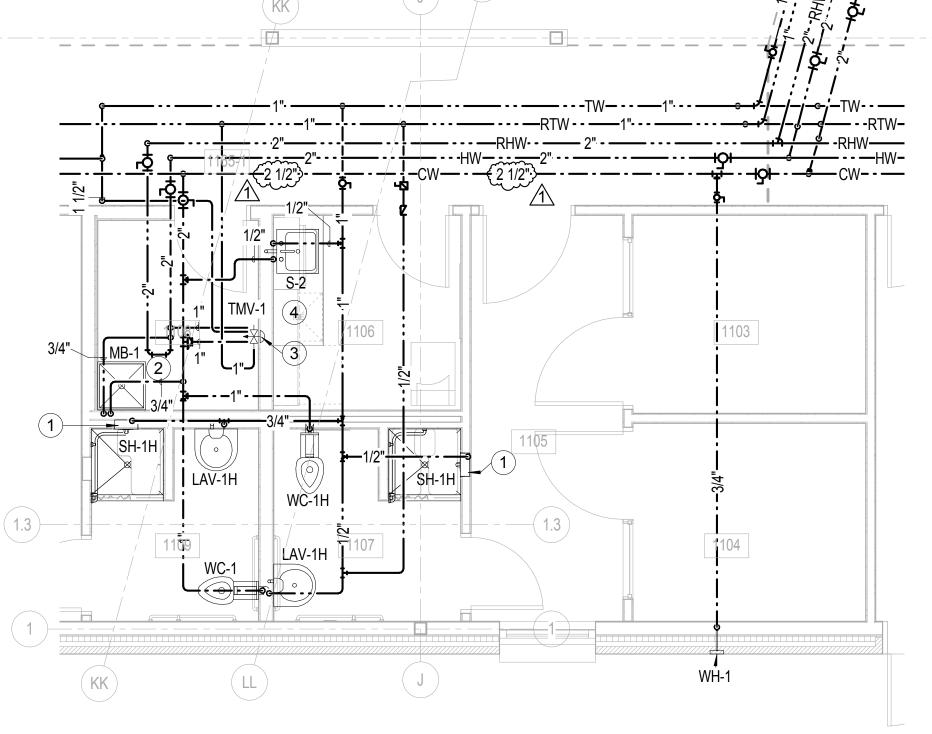

 $\frac{\text{NURSING UNIT 1 P-3}}{\text{SCALE: } 1/4" = 1'-0"}$

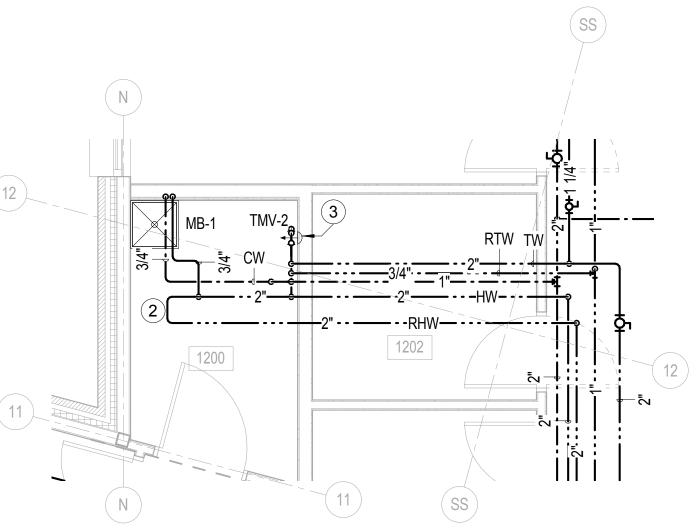

 $\frac{\text{NURSING UNIT 2 P-5}}{\text{SCALE: } 1/4" = 1'-0"}$

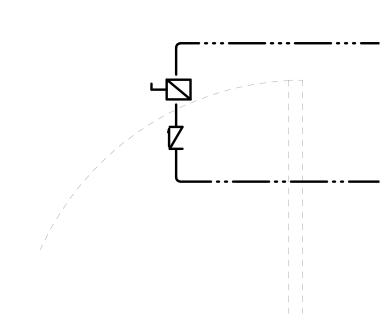

<u>NOTES</u>

. SEE FLOOR PLANS FOR PIPE SIZES.
. MANUAL BALANCING VALVES SHALL BE BALL TYPE VALVE WITH MEMORY STOP. FURNISH AND INSTALL VALVE WITH SAME SIZE AS RECIRCULATING PIPE SIZE. BALANCING CONTRACTOR SHALL ADJUST AS NECESSARY FOR PROPER GPM FLOW.

TYPICAL RECIRCULATING LOOP P-6

SCALE: 1" = 1'-0"



- REFER TO SHEET E001 AND M001 FOR ADDITIONAL NOTES
 WATER HAMMER ARRESTORS (WHA-1) SHALL BE INSTALLED ON ALL CW BRANCH LINES TO TOILETS AND LAUNDRY AREAS/HW BRANCH PIPING TO LAUNDRY AREAS. UNITS SHALL BE INSTALLED IN AN ACCESSIBLE LOCATION
- IN AN ACCESSIBLE LOCATION.

 3. TRAP PRIMERS SHALL BE FURNISHED AND INSTALLED FOR ALL FLOOR DRAINS. CW PIPING SHALL BE 1/2" TYPE K COPPER. PRIMERS AND DISTRIBUTION UNITS SHALL BE INSTALLED IN AN
- ACCESSIBLE LOCATION.

 4. ALL SHUT-OFF VALVES SERVING THE PATIENT ROOMS SHALL BE
- LOCATED IN CORRIDOR ACCESSIBLE CEILING.

 5. MINIMUM PIPE SIZE TO FIXTURES IS 3/4". REDUCE TO 1/2" AT
- FIXTURE WHERE 1/2" PIPE IS REQUIRED

 6. ALL BRANCH LINES (CW/HW/TW) SHALL HAVE A SHUT-OFF VALVE
- FOR ISOLATION.
 7. ALL PLUMBING FIXTURES PIPED WITH CW AND HW/TW SHALL BE INSTALLED WITH CW LOCATED ON THE RIGHT AND HW/TW ON
- THE LEFT

 8. REFER TO ARCHITECTURAL DRAWINGS FOR MOUNTING HEIGHTS
 AND COORDINATION OF FINAL LOCATION OF DEVICES AND
- FIXTURES.


 9. REFER TO SCHEDULE FOR REQUIRED SIZE(S) OF PIPING
- CONNECTIONS.

 10. REFER TO THE ROOM VENTILATION SCHEDULE FOR ROOM NAMES AND NUMBERS ON SHEET M602

⊗ PLAN NOTES

- 1 CONTRACTOR SHALL FURNISH AND INSTALL BALL VALVE IN VERTICAL PIPING TO SHOWER LOCATED BEHIND ACCESSIBLE SHOWER PANEL. TYPICAL FOR ALL SHOWERS.
- 2 REFER TO TYPICAL DOMESTIC WATER LAYOUT P-6.
- REFER TO TMV PIPING DETAIL FOR ADDITIONAL INFORMATION.
- 4 RUN 1/2" CW TO ICEMAKER SUPPLY BOX (IB-1).

 5 SINK FURNISHED & INSTALLED BY KITCHEN EQUIPMENT SUPPLIER. FINAL CONNECTIONS BY PLUMBING CONTRACTOR.

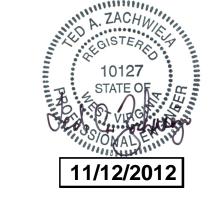

Design/Consulting Services

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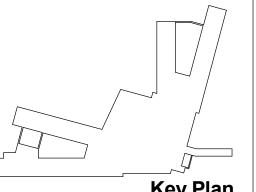
architecture


IKM Incorporated One PPG Place

interior design


Pittsburgh, PA 15222

planning



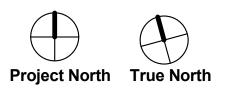

Did Co.

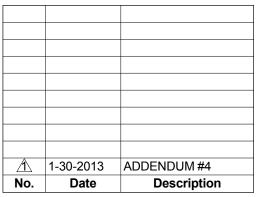

Revision

Date
14 November 2012

Project Title

WILLIAM R SHARPE HOSPITAL

50 Bed Addition

WSH130


936 Sharpe Hospital Road Weston, WV 26452-8550

Drawing Title ENLARGED PLUMBING PLANS


Project Number

11-170

Drawing Number P204

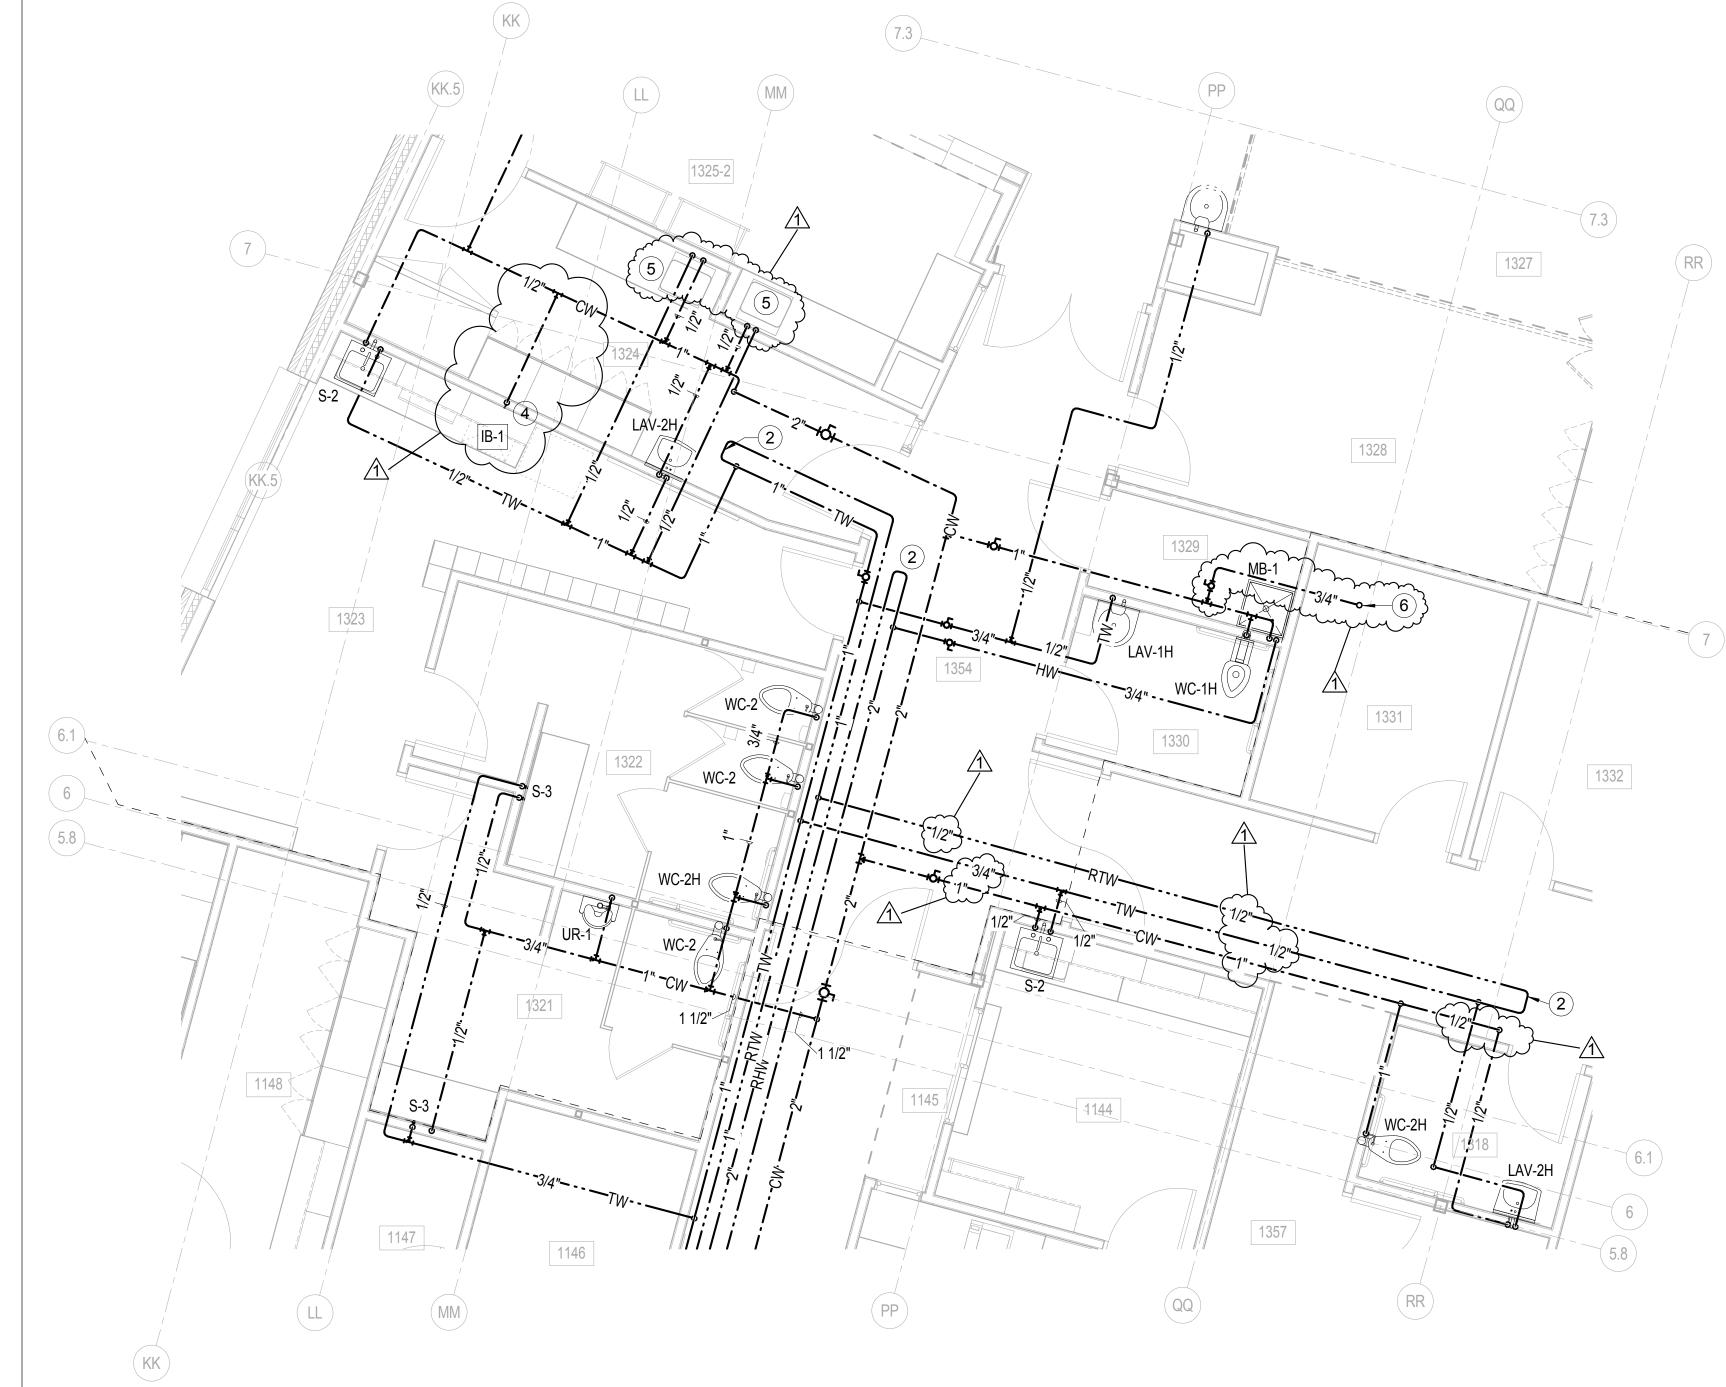

 $\frac{\text{NURSING UNIT 1 P-4}}{\text{SCALE: } 1/4" = 1'-0"}$

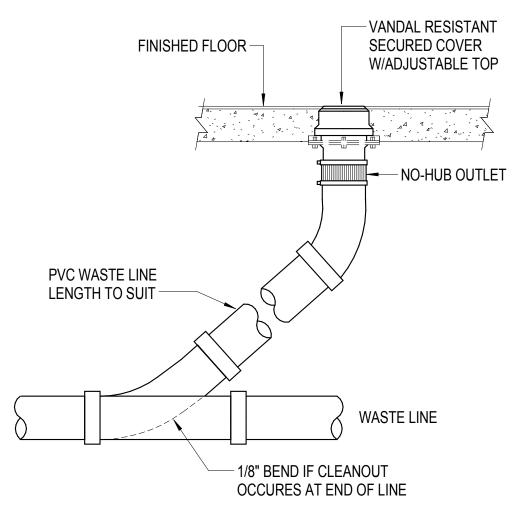

NOTE:
FLOOR CLEANOUTS SHALL BE ZURN SERIES Z1400 / ZN1400 IN ALL AREAS.

ZURN AUTOMATIC TRAP PRIMER

(HORIZONTAL INSTALLATION) -

FINISHED FLOOR

DEEP-SEAL P-TRAP -


VALVE MODEL #Z-1022 CONCEALED IN CEILING & ACCESSIBLE LOCATION


PROVIDE ACCESS

ACCESSIBLE CEILING -

DOOR IN NON-


TYPICAL FLOOR **CLEANOUT DETAIL** NOT TO SCALE

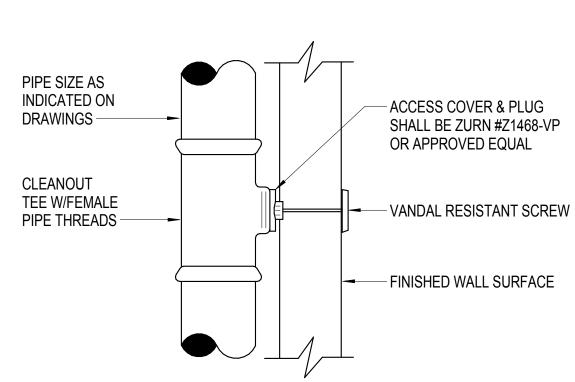

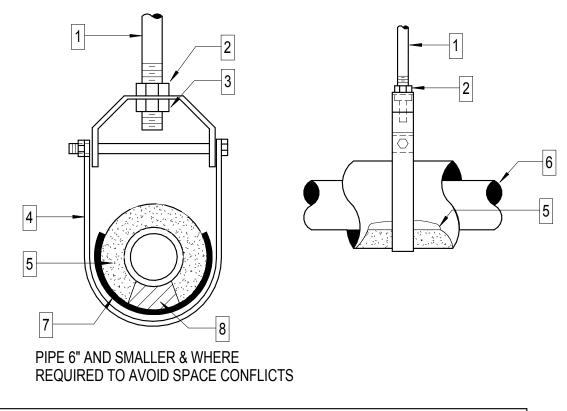


							-					
HANGER ROD SPACING												
PIPE SIZE	1"	1-1/4"	1-1/2"	2"	2-1/2"	3"	4"	5"	6"	8"	10"	12"
MAX ALLOWABLE SPACING	7 FT.	8 FT.	9 FT.	10 FT.	11 FT.	12 FT.	14 FT.	16 FT.	17 FT.	19 FT.	22 FT.	23 FT.
NOTE: FOR TRAPEZE HANGER TAKE SPACING OF SMALLEST PIPE ON TRAPEZE												

TYPICAL PIPE HANGER DETAIL NOT TO SCALE

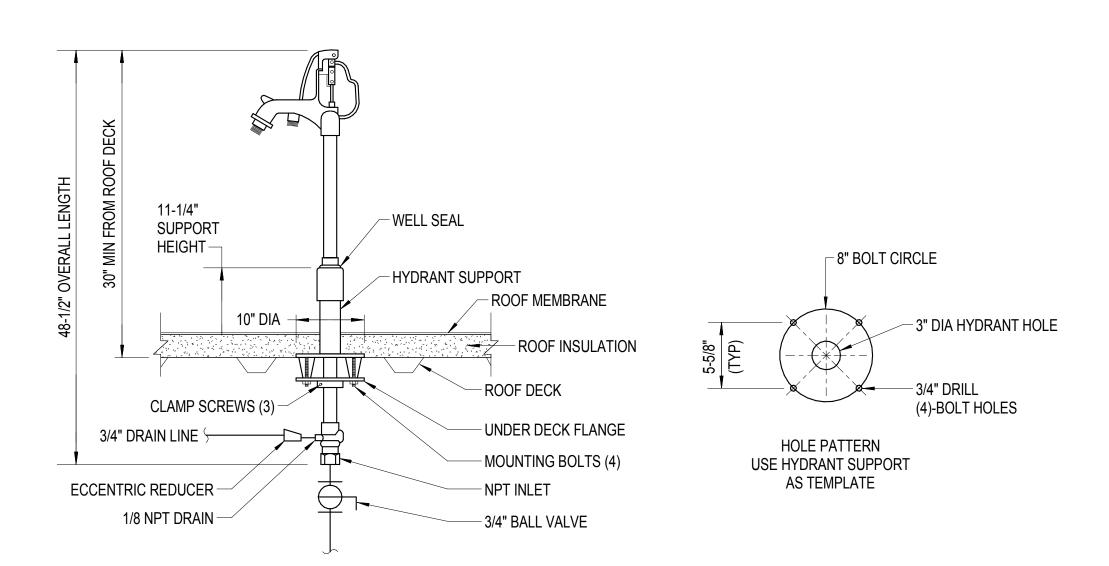


1. FREEZELESS ROOF HYDRANT SHALL BE ZURN MODEL #Z1388 OR APPROVED EQUAL. 2. CONTRACTOR SHALL PROVIDE WATERTIGHT SEAL WITH FLASHING OR BOOT AT ROOF PENETRATION.

FREEZELESS ROOF HYDRANT DETAIL NOT TO SCALE

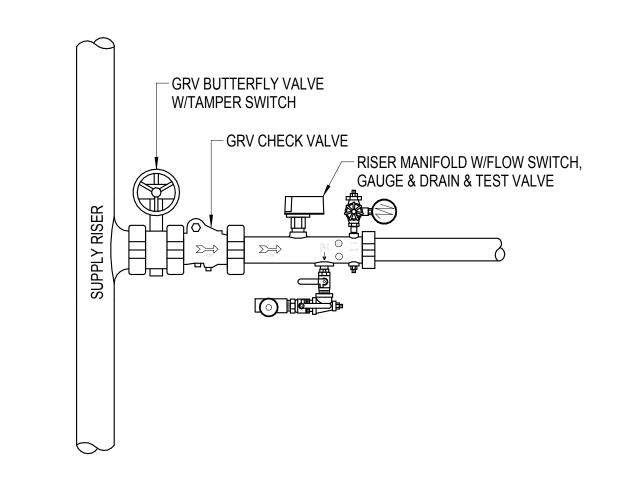

TYPICAL SPRINKLER ZONE CONTROL ASSEMBLY

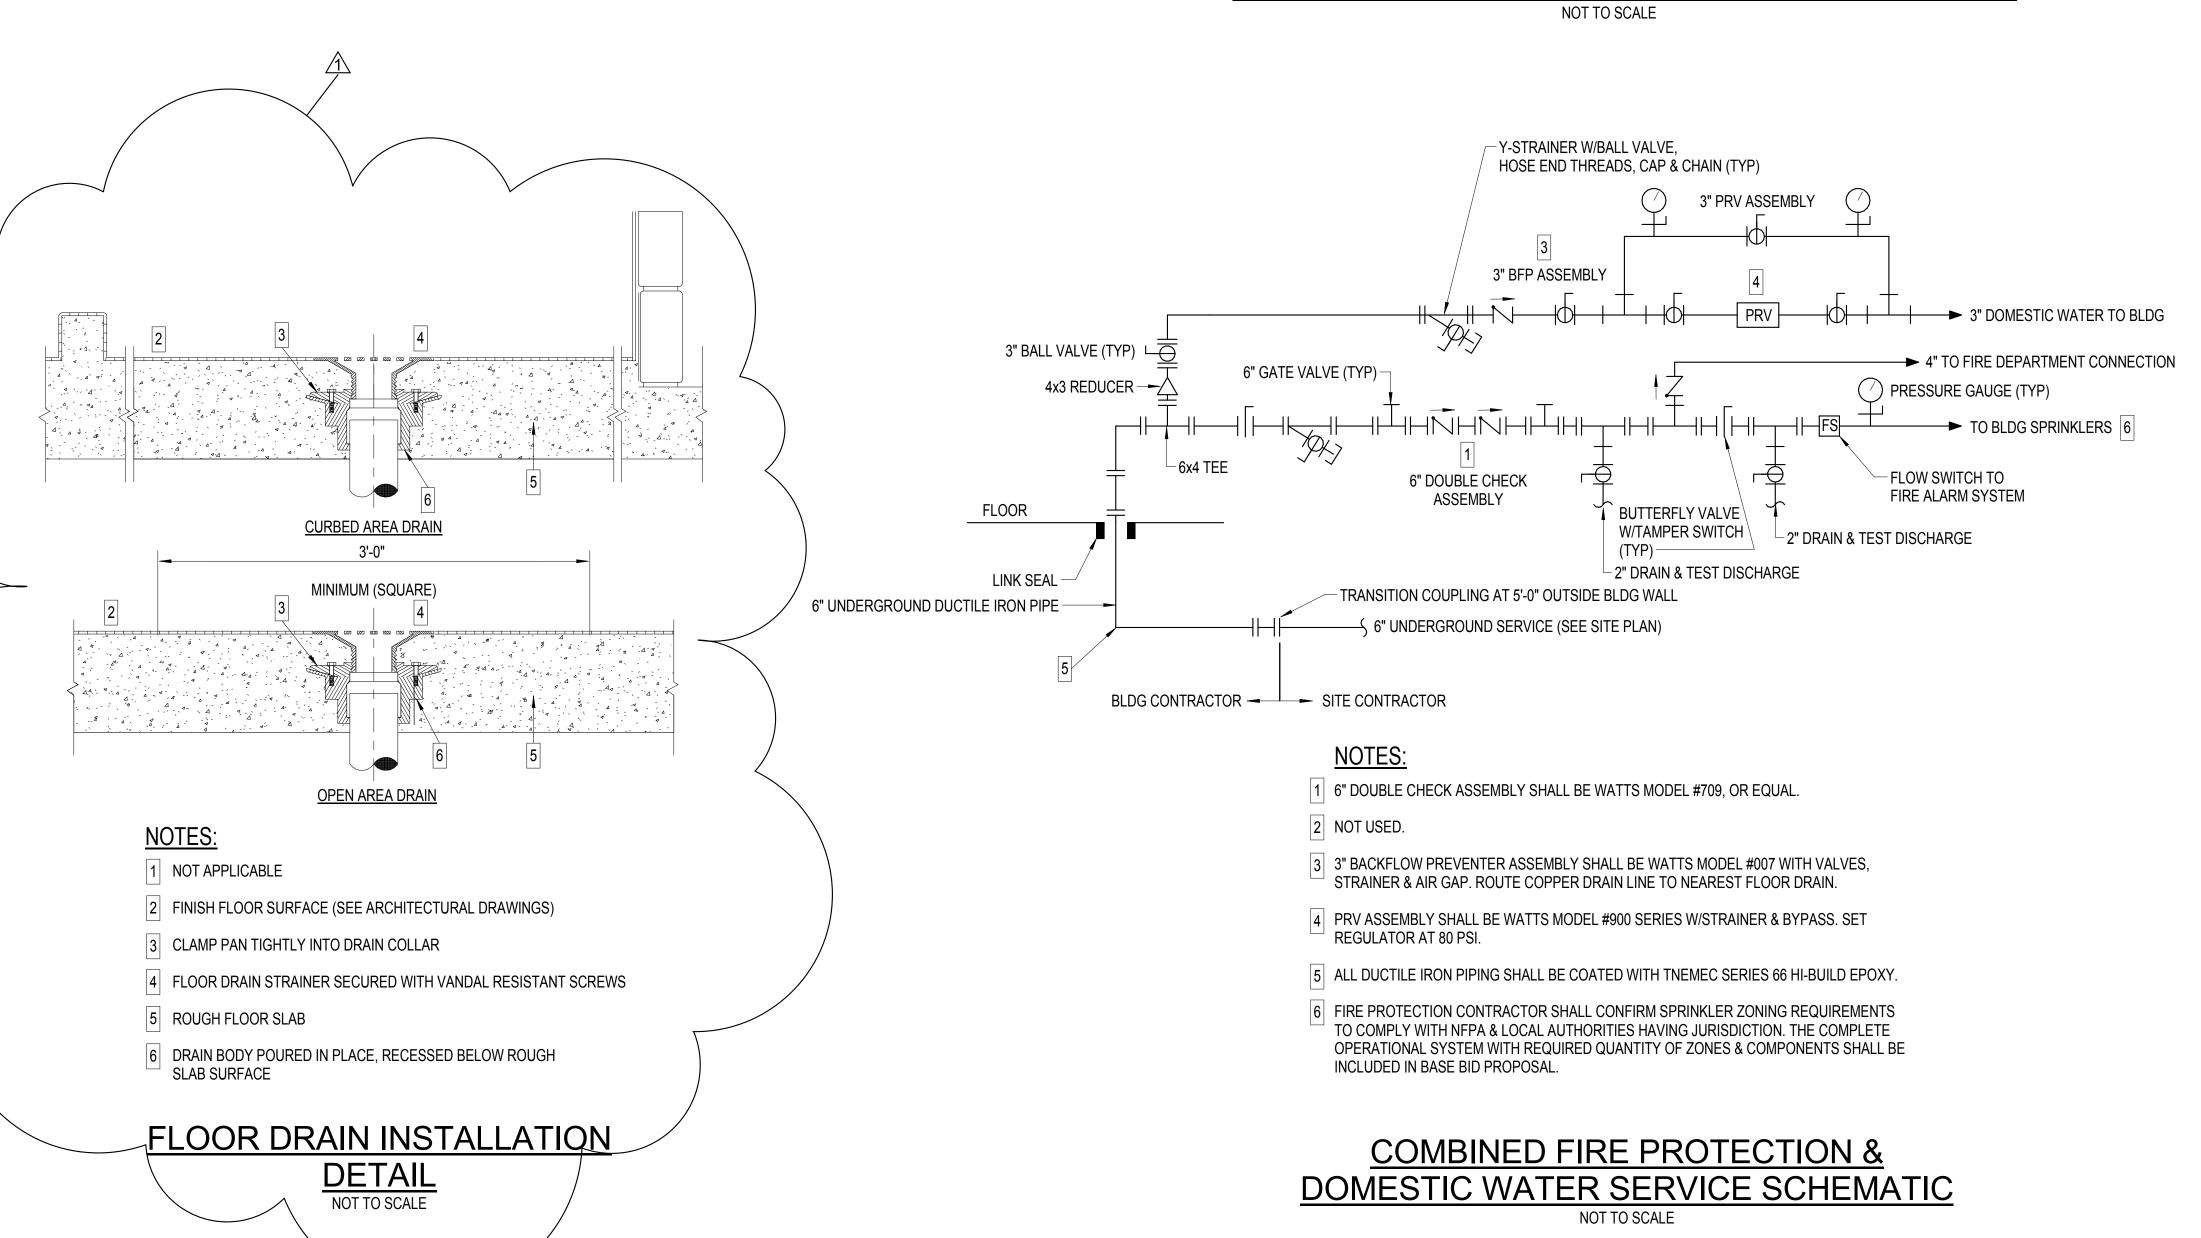





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Bid Set

Date

14 November 2012 **Project Title WILLIAM R SHARPE** HOSPITAL

50 Bed Addition

WSH13095


936 Sharpe Hospital Road Weston, WV 26452-8550

Drawing Title PLUMBING DETAILS

Project Number

11-170

Drawing Number P401

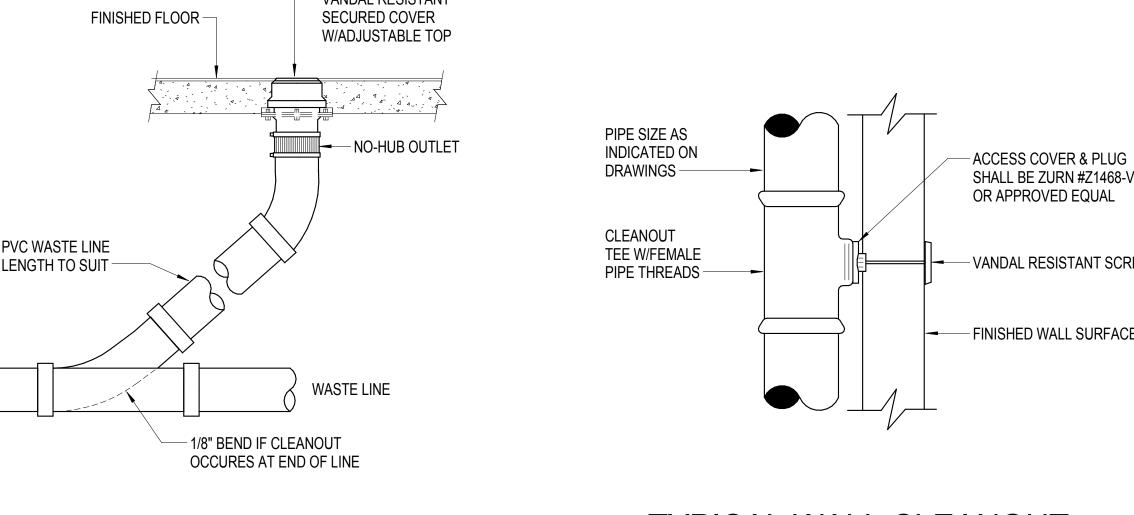

CHECK VALVE (TYP)

SHUT-OFF VALVE (TYP)

ZURN AUTOMATIC TRAP PRIMER VALVE MODEL #Z-1022 CONCEALED IN CEILING

ACCESSIBLE

CEILING

- CONCEALED IN WALL OR CHASE

PRIMER LINE

TYPE "K" SOFT


FLOOR DRAIN FOR CONCRETE

FLOOR W/TRAP PRIMER DETAIL

COPPER W/NO JOINTS

& ACCESSIBLE LOCATION (VERTICAL INSTALLATION)


TYPICAL WALL CLEANOUT W/ACCESS COVER DETAIL NOT TO SCALE

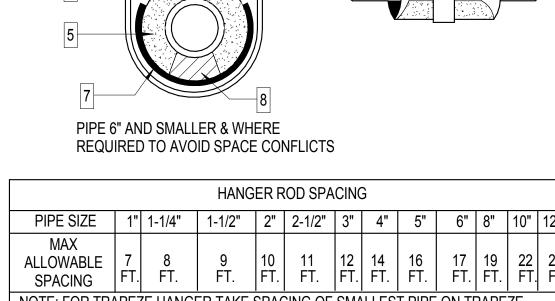


HANGER ROD SCHEDULE PIPE SIZE ROD SIZE PIPE SIZE ROD SIZE 3/8"DIA. 4" THRU 5" 5/8"DIA. 2-1/2" THRU 3" 1/2"DIA. 6" THRU 12" 7/8"DIA.

NOTES


1 HANGE	R ROD 4	HEAVY DUTY CLEVIS HANGER	8 WOOD BLOCKS
2 LOCKIN	G NUT 5	INSULATION (WHERE REQUIRED)	
3 SUPPO	RT NUT 6	PIPE	
	7	14 GAUGE ZINC COATED SHEET STEEL SADDLE AT LEAST 6" LONG	

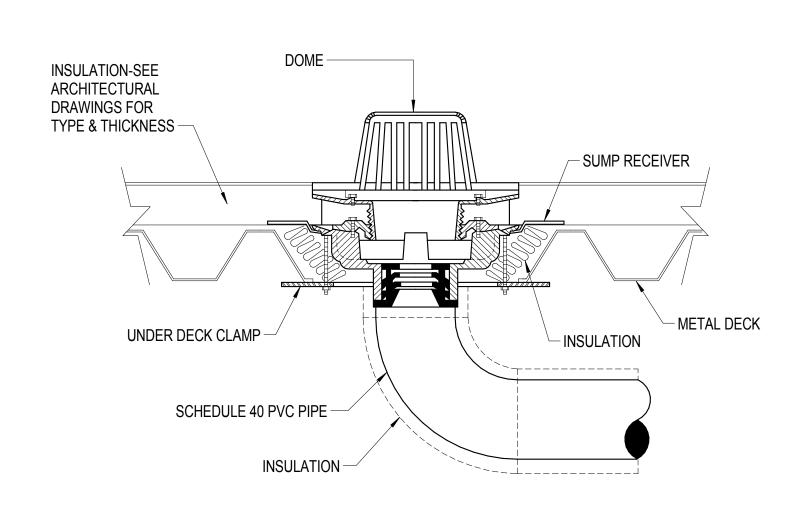


ROOF DRAIN DETAIL NOT TO SCALE

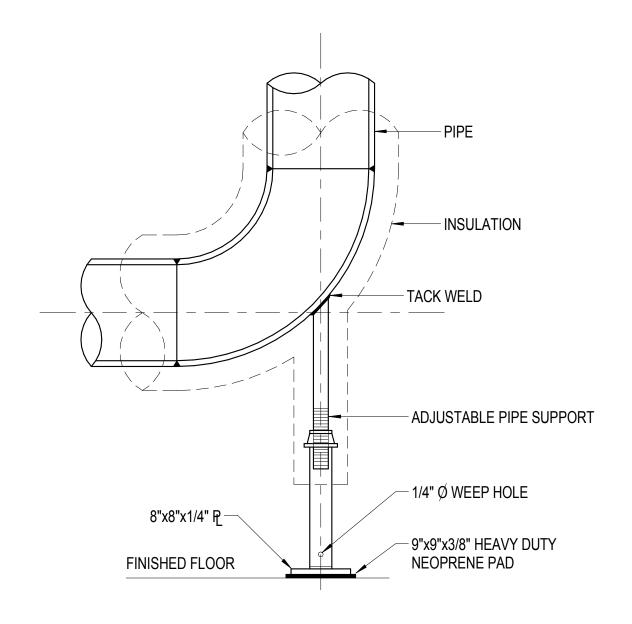


PIPE SUPPORT DETAIL NOT TO SCALE

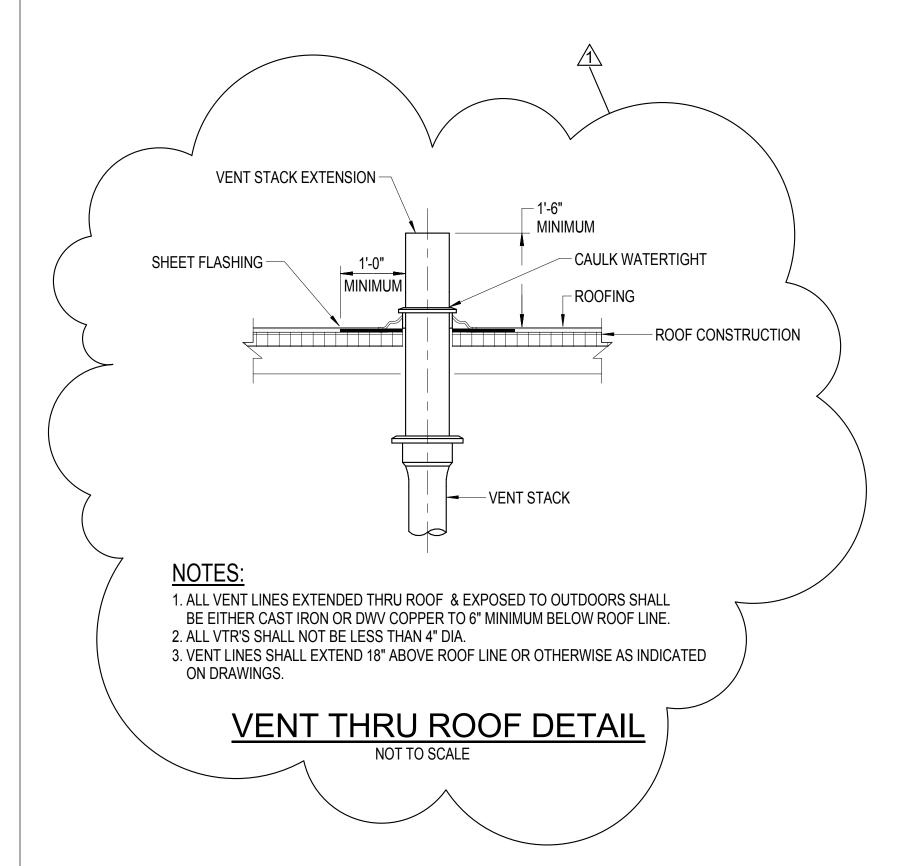

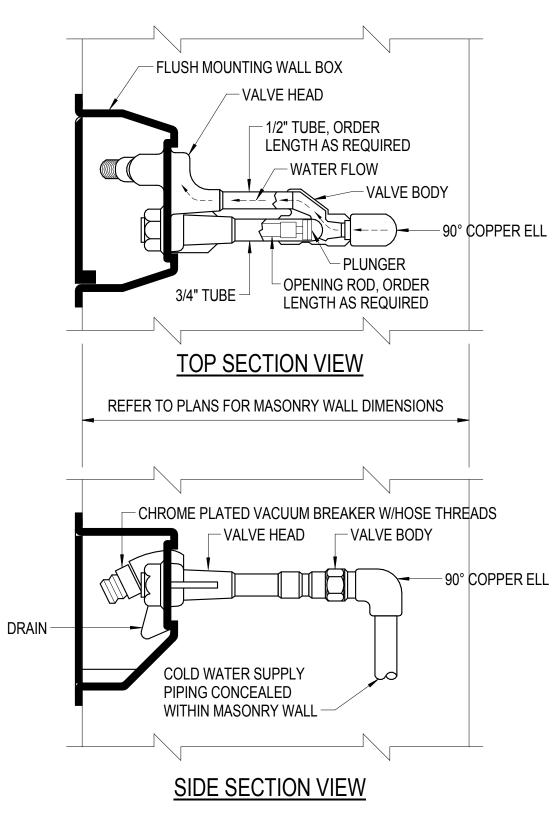



NOTE:
AUTOMATIC DRAINING NON-FREEZE WALL HYDRANT (CHROME FINISH ON BRASS

TYPICAL OUTSIDE NON-FREEZE WALL HYDRANT DETAIL

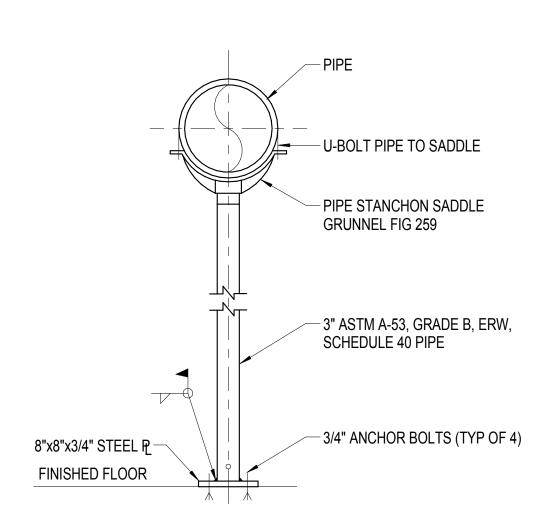


PIPE SUPPORT DETAIL NOT TO SCALE

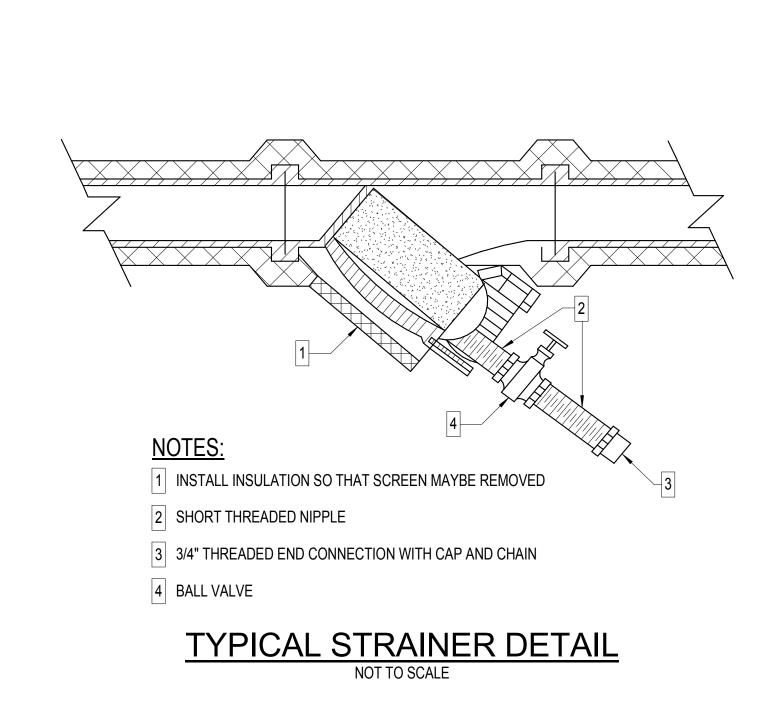

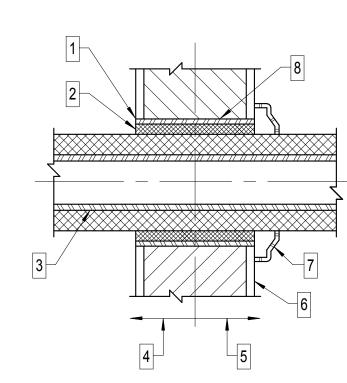


- 1 TERMINATE SLEEVE FLUSH WITH FINISHED WALL SURFACES.
- 2 SEAL OR CAULK SLEEVES THRU FIRE WALLS IN A SMOKE TIGHT MANNER.
- 3 PIPE & INSULATION TO BE CENTERED IN SLEEVE (DO NOT SUPPORT PIPE FROM SLEEVE).
- 4 CONCEALED PIPING.
- 5 PIPING EXPOSED TO VIEW.
- 6 FINISHED WALL SURFACE.
- 7 FINISHED ESCUTCHEON PLATE FLUSH AGAINST WALL & OF SIZE TO COMPLETELY COVER
- 8 PIPE SLEEVE OF SIZE TO PASS PIPE & INSULATION WITH ANNULAR SPACE AS REQUIRED

PIPE THRU WALL DETAIL

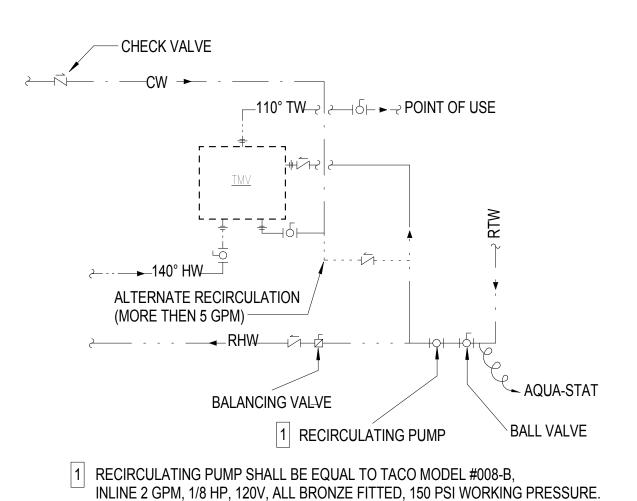

TMV PIPING DETAIL

NOT TO SCALE

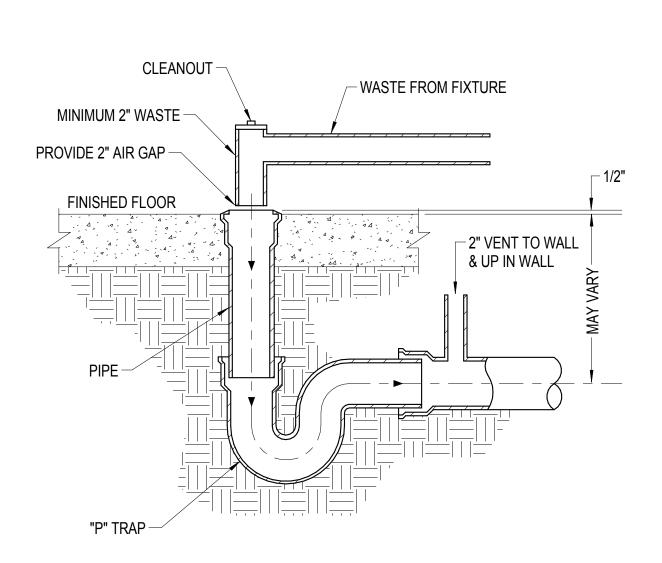

HUB DRAIN USED FOR INDIRECT WASTE NOT TO SCALE






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Bid Set



Date

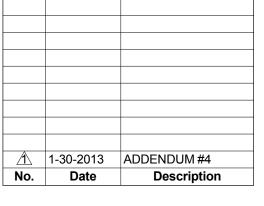14 November 2012 **Project Title WILLIAM R SHARPE**

> HOSPITAL 50 Bed Addition

WSH13095

936 Sharpe Hospital Road Weston, WV 26452-8550 **Drawing Title**

PLUMBING DETAILS

Project Number

11-170

Drawing Number

P402