



State of West Virginia
 Department of Administration
 Purchasing Division
 2019 Washington Street East
 Post Office Box 50130
 Charleston, WV 25305-0130

Solicitation

NUMBER
DNRB13202

PAGE
1

ADDRESS CORRESPONDENCE TO ATTENTION OF:
GUY NISBET 304-558-8802

VENDOR

RFQ COPY
 TYPE NAME/ADDRESS HERE

SHIP TO

DIVISION OF NATURAL RESOURCES
 JOBSITE
 SEE SPECIFICATIONS

DATE PRINTED
04/24/2013

BID OPENING DATE: 05/09/2013 BID OPENING TIME 1:30PM

LINE	QUANTITY	UOP	CAT. NO.	ITEM NUMBER	UNIT PRICE	AMOUNT
ADDENDUM NO. 2						
THE ADDENDUM FOR THE BLACKWATER FALLS STATE PARK; SLED RUN SNOW MAKING IMPROVEMENTS PROJECT, ISSUED TO DISTRIBUTE THE FOLLOWING ATTACHED INFORMATION TO THE VENDOR COMMUNITY.						
0001	1	LS		968-42		
GENERAL CONSTRUCTION / SNOW MAKING PROJECT						
***** THIS IS THE END OF RFQ DNRB13202 ***** TOTAL: _____						

SIGNATURE	TELEPHONE	DATE
-----------	-----------	------

TITLE	FEIN	ADDRESS CHANGES TO BE NOTED ABOVE
-------	------	-----------------------------------

WHEN RESPONDING TO SOLICITATION, INSERT NAME AND ADDRESS IN SPACE ABOVE LABELED 'VENDOR'

SOLICITATION NUMBER: DNRB13202
 Addendum Number: No.2

The purpose of this addendum is to modify the solicitation identified as (“Solicitation”) to reflect the change(s) identified and described below.

Applicable Addendum Category:

- Modify bid opening date and time
- Modify specifications of product or service being sought
- Attachment of vendor questions and responses
- Attachment of pre-bid sign-in sheet
- Correction of error
- Other

Description of Modification to Solicitation:

The addendum for the Blackwater Falls State Park; Sled Run Snow making Improvements issued to distribute the following information to the vendor community.

1. Technical Clarifications
2. No other changes.

Additional Documentation: Documentation related to this Addendum (if any) has been included herewith as Attachment A and is specifically incorporated herein by reference.

Terms and Conditions:

1. All provisions of the Solicitation and other addenda not modified herein shall remain in full force and effect.
2. Vendor should acknowledge receipt of all addenda issued for this Solicitation by completing an Addendum Acknowledgment, a copy of which is included herewith. Failure to acknowledge addenda may result in bid disqualification. The addendum acknowledgement should be submitted with the bid to expedite document processing.

ATTACHMENT A



WEST VIRGINIA DIVISION OF NATURAL RESOURCES
BLACKWATER FALLS STATE PARK
SLED RUN SNOW MAKING IMPROVEMENTS
TUCKER COUNTY, WEST VIRGINIA

CONTRACT NO. 2

April 23, 2013

**ADDENDUM NO. 2
TECHNICAL CLARIFICATIONS**

A. GENERAL

1. The existing pond has been substantially dewatered. Puddling, saturated soil, etc. may still be present. Dewatering occurred on or about April 19, 2013. The drain will remain open until disturbed by the Contractor's construction activities.

B. SPECIFICATIONS

1. Add paragraph 2.2-C to specification section 02200 as follows:

C. Pond Liner Separation Geotextile (LP12): Needle-punched non-woven fabric, manufactured for filtration, separation, protection, and drainage applications, made from polypropylene fibers that are tangled together, conforming to the following:

1. Grab Tensile Strength: 300 lbs; ASTM D 4632
2. Elongation: 50%; ASTM D 4632
3. Tear Strength: 115 lbs; ASTM D 4533
4. CBR Punc: 790 lbs; ASTM D6241
5. Apparent Opening size: No.100 sieve maximum; ASTM D 4751
6. Permittivity: 0.8 per second minimum; ASTM D 4491
7. Water flow: 65 gpm/ft²; ASTM D 4491
8. UV Stability: 70 percent after 500 hours exposure; ASTM D 4355


2. Replace "LP8" with "LP12" in specification section 13201, paragraph 3.1-D.
3. Revise specification section 11276, paragraph 2.13-L-1 to read as follows:

The pump skid shall be field wired to the remote mounted control panel per the system suppliers instructions, and in accordance with the NEC.

200 Sixth Avenue
St. Albans, WV 25177
304.727.5501
FAX 304.727.5580

Buckhannon, WV
Martinsburg, WV


www.chaptech.com

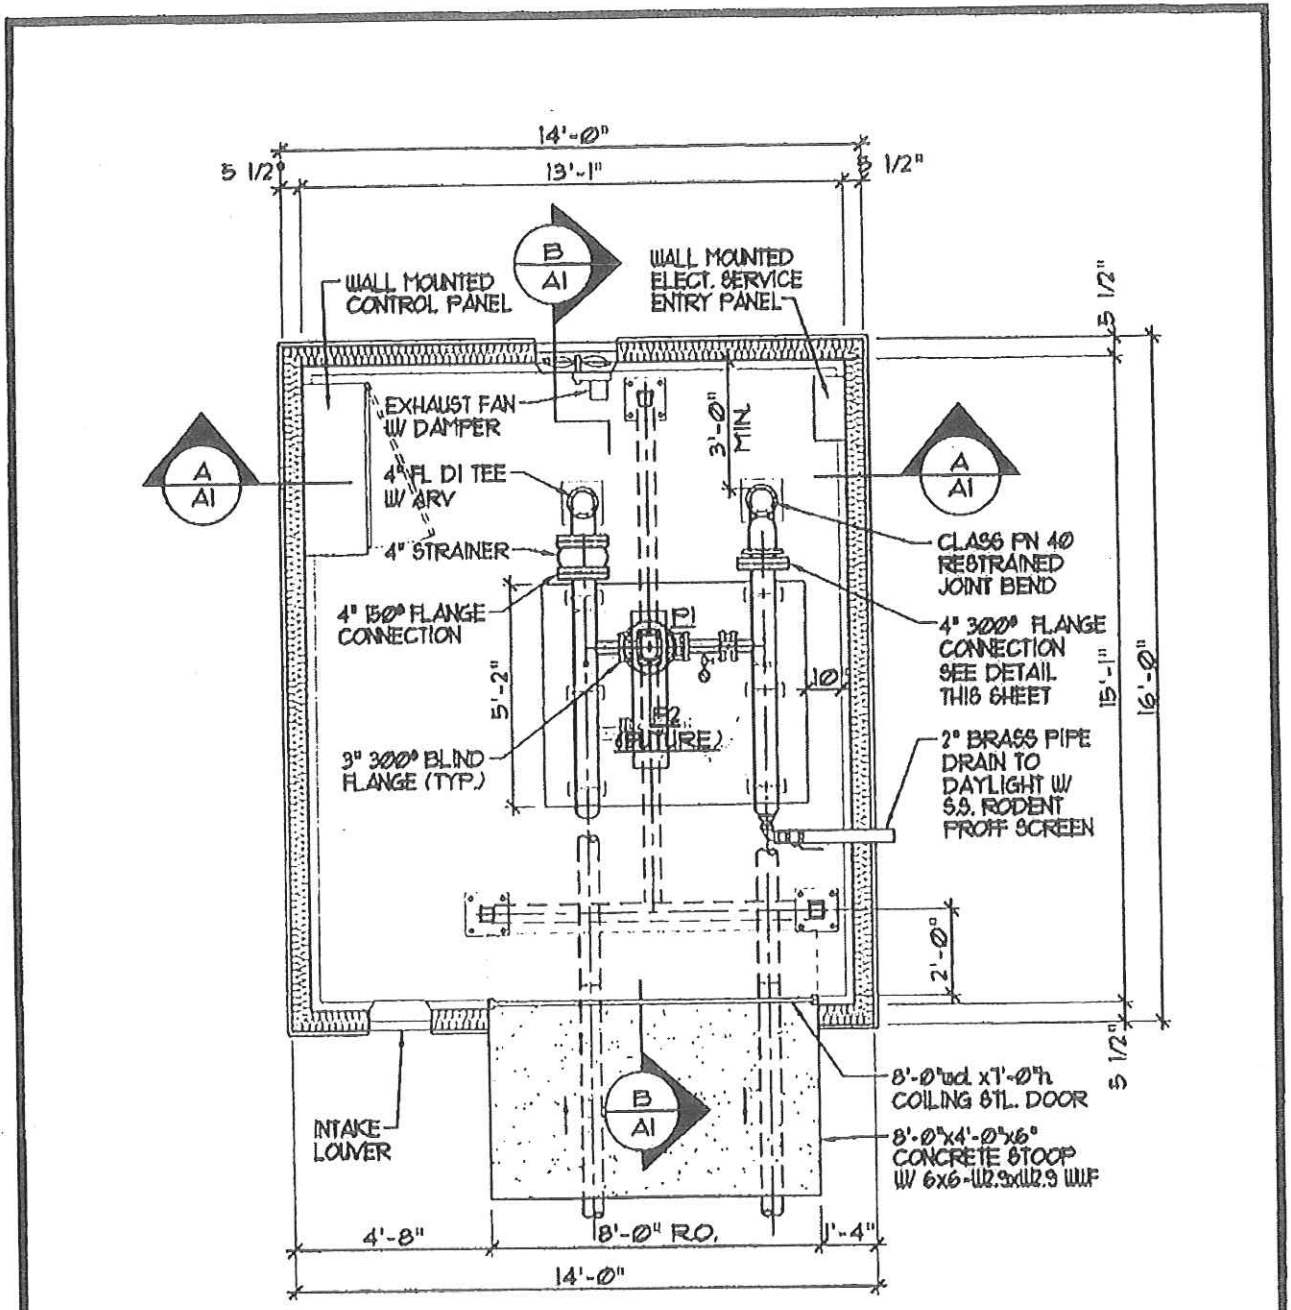

FLOOR PLAN
 SCALE : 1/4" = 1'-0"

P:\Projects\10\10224\CADD\CONTROL 2\Cons\B.3x11_455ENBou\10064_455-A1-A.dwg 4/23/2013 11:23:05 AM JEB

 <p>Chapman Technical Group</p>	AIRPORT PLANNING / DEVELOPMENT	61 Albana, WV (304) 727-5521	WV DIVISION OF NATURAL RESOURCES PARKS AND RECREATION BLACKWATER FALLS STATE PARK SLED RUN SNOW MAKING IMPROVEMENTS PUMP BUILDING FLOOR PLAN	JOB NUMBER	10064
	ARCHITECTURE / INTERIOR DESIGN	Buckhannon, WV (304) 472-4114		WORLD	AS SHOWN
	CIVIL ENGINEERING / SITE DEVELOPMENT	Marionburg, WV (304) 266-1222		DATE	APRIL 2013
	ENVIRONMENTAL ENGINEERING	www.chaptech.com		DRAWN BY	ELB
	LANDSCAPE ARCHITECTURE			CHECKED BY	SUJ
SURVEYING				CHECKED BY	JEB
				SHEET NO.	A1-A
				PROJECT	△

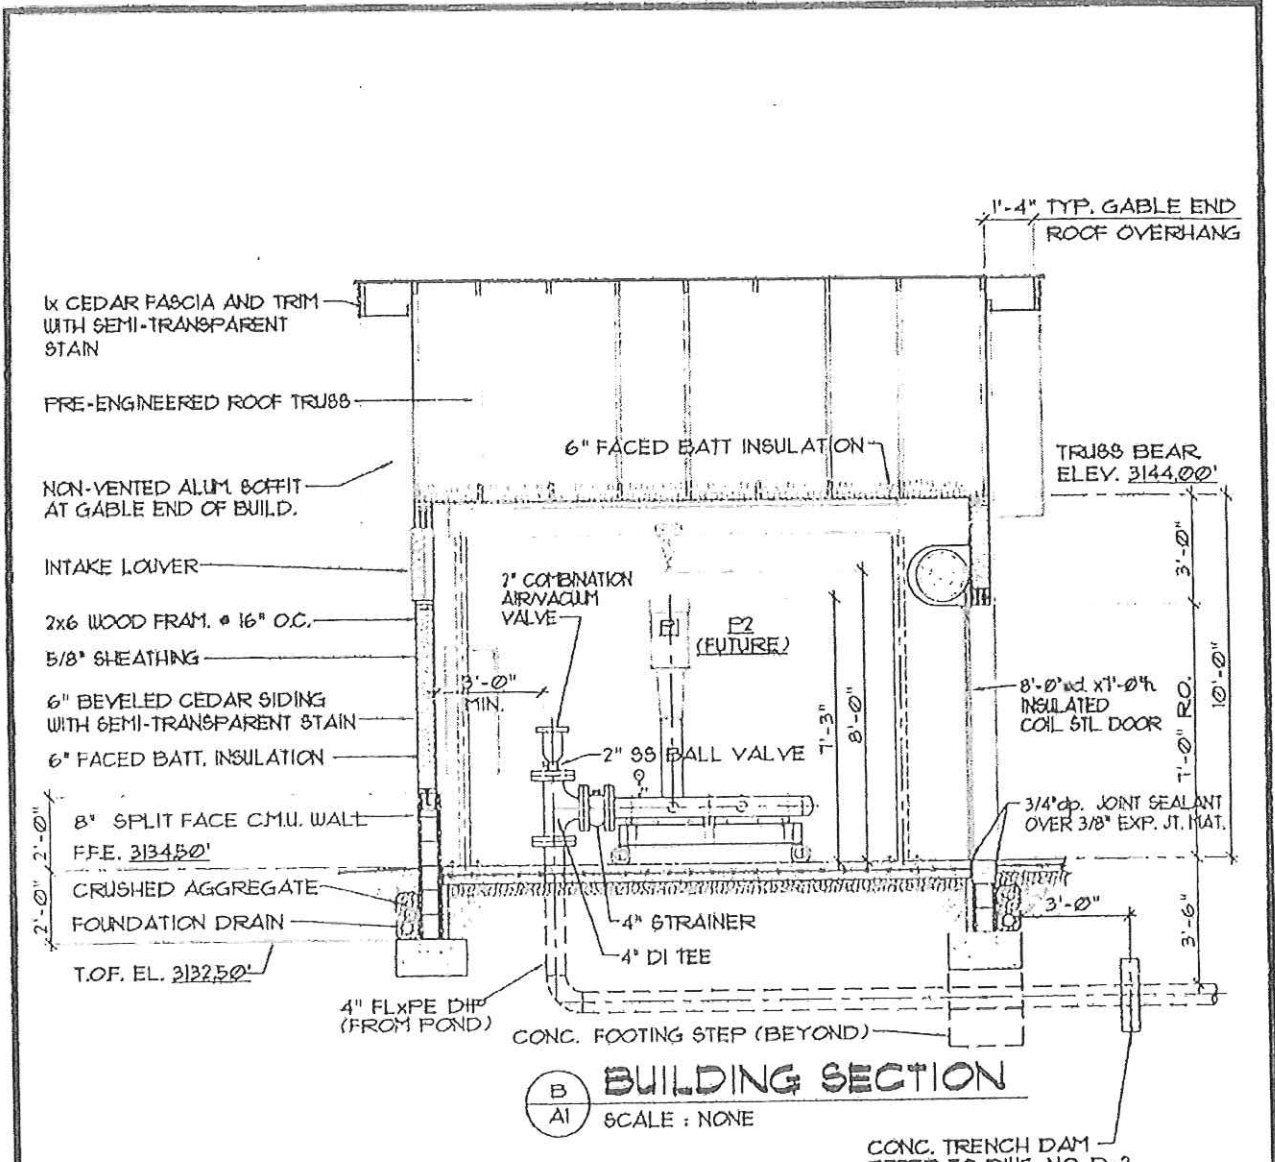


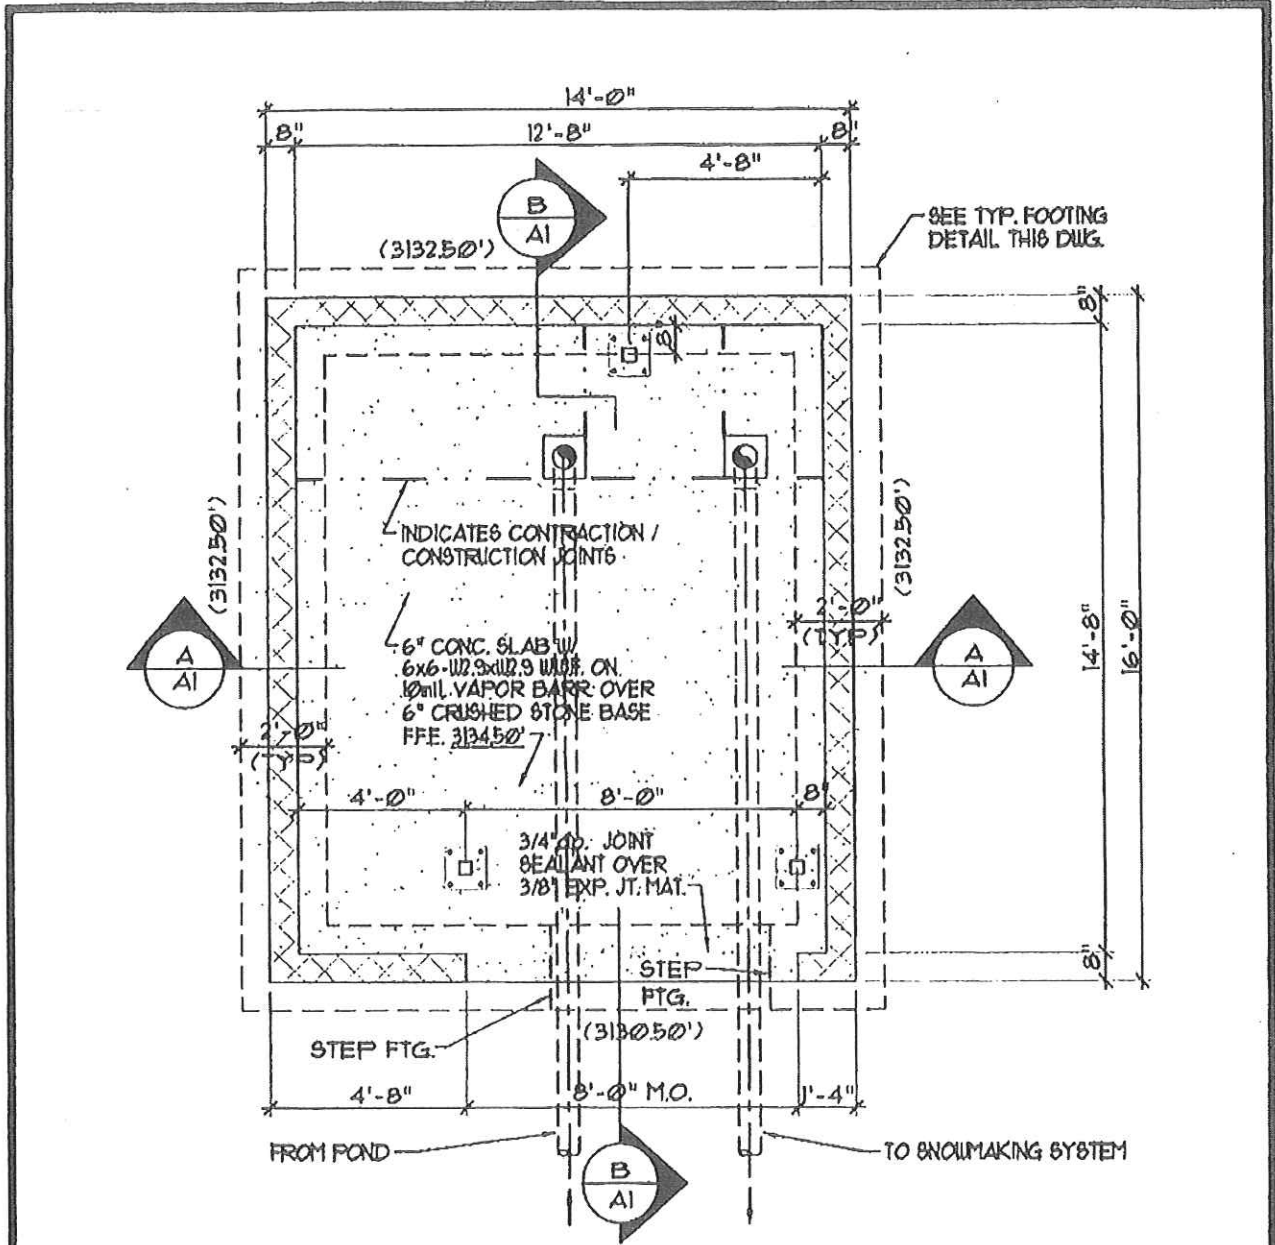
B BUILDING SECTION
 AI SCALE : NONE

CONC. TRENCH DAM REFER TO DWG. NO. D-2

NOTES:

1. PROVIDE POLYETHYLENE WRAP ON ALL PIPING BELOW BUILDING SLAB.
2. PROVIDE STEEL TROLLEY, BEAM AND SUPPORTS AS SHOWN WITH MINIMUM 1,000 POUND LIFTING CAPACITY. STEEL DESIGN BY SUPPLIER.
3. ALL DISCHARGE PIPING AND CONNECTIONS SHALL BE RATED FOR A MINIMUM OF 400 PSI WORKING PRESSURE.

	AIRPORT PLANNING / DEVELOPMENT ARCHITECTURE / INTERIOR DESIGN CIVIL ENGINEERING / SITE DEVELOPMENT ENVIRONMENTAL ENGINEERING LANDSCAPE ARCHITECTURE SURVEYING	St Albans, WV (904) 721-5521 Buckhannon, WV (904) 472-9114 Marlinton, WV (904) 765-1222 www.chaptech.com	WY DIVISION OF NATURAL RESOURCES PARKS AND RECREATION BLACKCKWATER FALLS STATE PARK SLED RUN SNOW MAKING IMPROVEMENTS PUMP BUILDING SECTION	JOB NUMBER: 10084 SCALE: AS SHOWN DATE: APRIL 2013 DESIGNED BY: FLB DRAWN BY: SWJ CHECKED BY: JEB
				SHEET NO. A1-B




FOUNDATION PLAN
SCALE : 1/4" = 1'-0"

- NOTES:**
1. TOP OF FOOTING ELEV. INDICATED THIS () ON PLAN.
 2. GROUT ALL MAS. WALLS SOLID BELOW GRADE.

<p>Chapman Technical Group</p>	AIRPORT PLANNING / DEVELOPMENT	Sl Albans, WV (504) 727-5501	WV DIVISION OF NATURAL RESOURCES PARKS AND RECREATION BLACKCKWATER FALLS STATE PARK SLED RUN SNOW MAKING IMPROVEMENTS PUMP BUILDING FOUNDATION PLAN	JOB NUMBER	10084
	ARCHITECTURE / INTERIOR DESIGN	Buckhannon, WV (504) 472-6114		BUILD	AS SHOWN
	CIVIL ENGINEERING / SITE DEVELOPMENT	Martinsburg, WV (504) 263-1222		DATE	APRIL 2013
	ENVIRONMENTAL ENGINEERING	www.chapttech.com		DRAWN BY	FLB
	LANDSCAPE ARCHITECTURE			DESIGNED BY	SLJ
SURVEYING				CHECKED BY	JEG
				Sheet No.	A1-C

I:\projects\1010264\CADD\CONTRAC\2\dwg\A1\50411 ADDENDUM\10084 ADD-A1.dwg 4/13/2013 11:23:42 AM 1/259

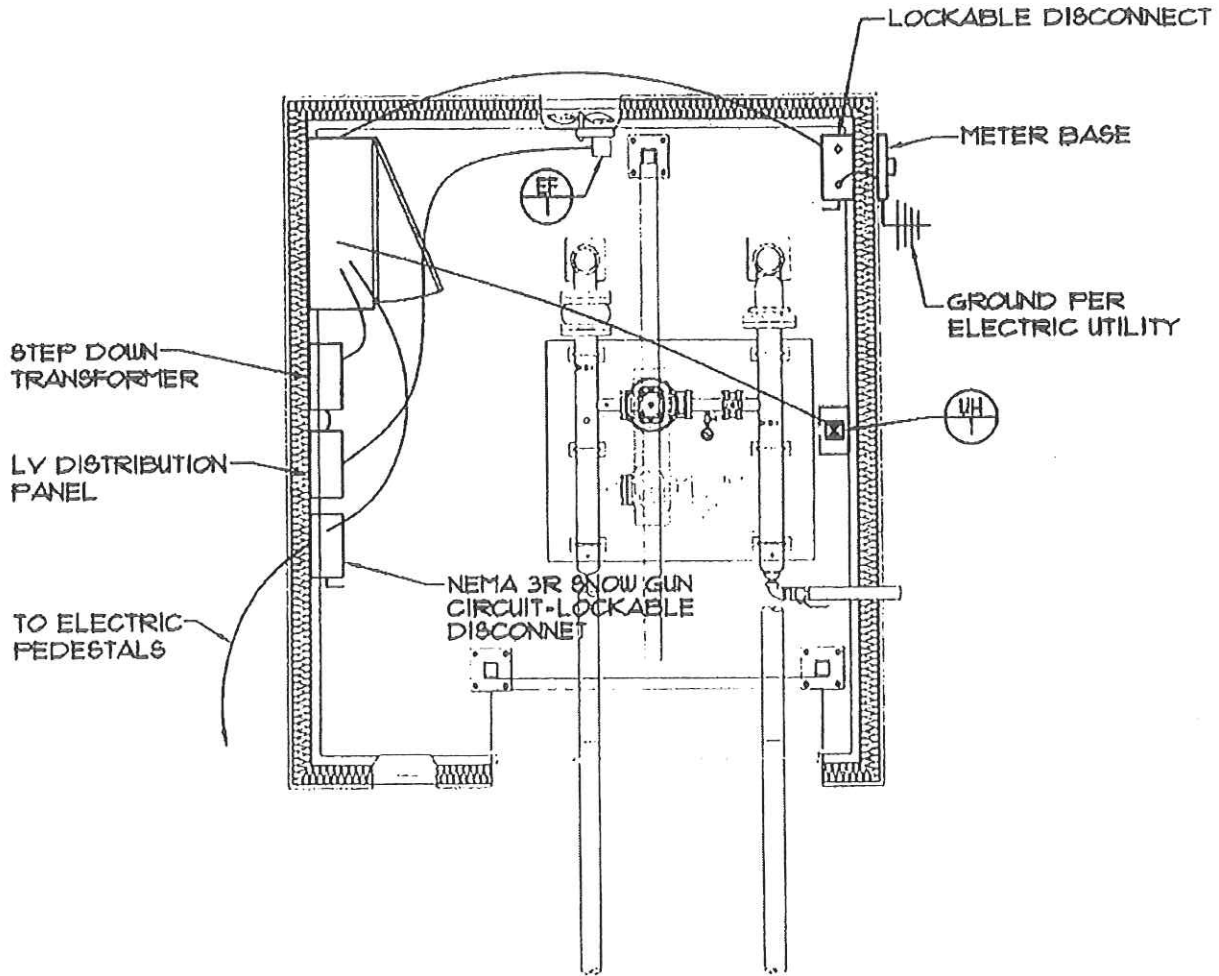

ELECT. FLOOR PLAN - POWER

SCALE : 1/4" = 1'-0"

- NOTES: 1. REFER TO ONE LINE DIAGRAM FOR CONDUCTOR SIZES.
 2. MIN. CONDUIT SIZES PER NEC.

H:\Projects\10110062\CADD\CONTRACT\3\CONTRACT\3\ADDENDUM\10062_ADD-CADD.dwg, 4/23/2013 1:37:30 PM, 1003


Chapman Technical Group

- AIRPORT PLANNING / DEVELOPMENT
- ARCHITECTURE / INTERIOR DESIGN
- CIVIL ENGINEERING / SITE DEVELOPMENT
- ENVIRONMENTAL ENGINEERING
- LANDSCAPE ARCHITECTURE
- SURVEYING

St Albans, WV (304) 727-6501
 Buckhannon, WV (304) 472-8914
 Martinsburg, WV (304) 200-1222
www.chapttech.com

WV DIVISION OF NATURAL RESOURCES
 PARKS AND RECREATION
 BLACKWATER FALLS STATE PARK
 SLED RUN SNOW MAKING IMPROVEMENTS
 PUMP BUILDING ELECTRIC PLAN

ADD NUMBER	10084
REVISED	AS SHOWN
DATE	APRIL 2013
DESIGNED BY	FLB
CHECKED BY	SLL
DATE	JEB
DIST NO.	E1-A
REVISION	△

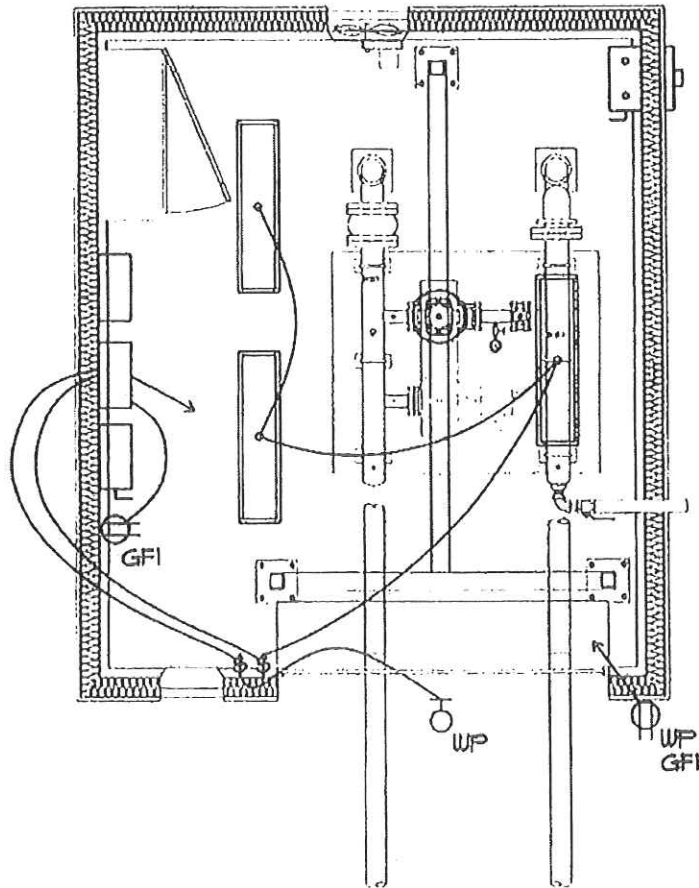

ELECT. FLOOR PLAN - LIGHTING & OUTLETS

SCALE : 1/4" = 1'-0"

NOTE: PROVIDE MIN. 12 GAUGE CONDUCTORS

I:\Projects\10\10064\CADD\CONTRACT 2\Notes\03.11.13.10064_400-ELC.dwg 4/23/2013 1:25:00 PM 1063



AIRPORT PLANNING / DEVELOPMENT
 ARCHITECTURE / INTERIOR DESIGN
 CIVIL ENGINEERING / SITE DEVELOPMENT
 ENVIRONMENTAL ENGINEERING
 LANDSCAPE ARCHITECTURE
 SURVEYING

St Albans, WV
 (204) 727-5501
 Buckhannon, WV
 (204) 472-6114
 Martinsburg, WV
 (204) 769-1222
www.chaptech.com

WV DIVISION OF NATURAL RESOURCES
 PARKS AND RECREATION
 BLACKWATER FALLS STATE PARK
 SLED RUN SNOW MAKING IMPROVEMENTS
 PUMP BUILDING LIGHTING PLAN

JOB NUMBER	10064
SCALE	AS SHOWN
DATE	APRIL 2013
DRAWN BY	FLB
CHECKED BY	SMJ
DATE	JEB
SHEET NO.	E1-B
TOTAL SHEETS	1

ADDENDUM ACKNOWLEDGEMENT FORM
SOLICITATION NO.: DNRB13202

Instructions: Please acknowledge receipt of all addenda issued with this solicitation by completing this addendum acknowledgment form. Check the box next to each addendum received and sign below. Failure to acknowledge addenda may result in bid disqualification.

Acknowledgment: I hereby acknowledge receipt of the following addenda and have made the necessary revisions to my proposal, plans and/or specification, etc.

Addendum Numbers Received:

(Check the box next to each addendum received)

- | | |
|---|--|
| <input type="checkbox"/> Addendum No. 1 | <input type="checkbox"/> Addendum No. 6 |
| <input type="checkbox"/> Addendum No. 2 | <input type="checkbox"/> Addendum No. 7 |
| <input type="checkbox"/> Addendum No. 3 | <input type="checkbox"/> Addendum No. 8 |
| <input type="checkbox"/> Addendum No. 4 | <input type="checkbox"/> Addendum No. 9 |
| <input type="checkbox"/> Addendum No. 5 | <input type="checkbox"/> Addendum No. 10 |

I understand that failure to confirm the receipt of addenda may be cause for rejection of this bid. I further understand that any verbal representation made or assumed to be made during any oral discussion held between Vendor's representatives and any state personnel is not binding. Only the information issued in writing and added to the specifications by an official addendum is binding.

Company

Authorized Signature

Date

NOTE: This addendum acknowledgment should be submitted with the bid to expedite document processing.
Revised 6/8/2012